


FOUNDATION PLAN
(SHOWING PILE CAP LOCATIONS)
SCALE = 1/16" = 1'-0"

CD'S ARE DATED ON 09/07/16

REF SHEETS: 2-A0.1 thru 2-A6.1 & 2-S1.0 thru 2-S5.3




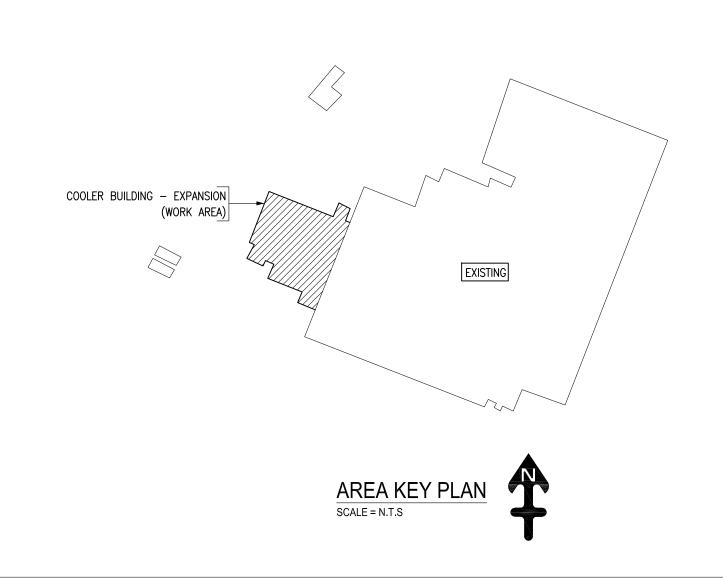



PILE SCHEDULE:

GRID REFERENCE	PILE QTY/DIA.	TOP ELEVATION	BOTTOM ELEVATION	PILE DEPTH	PIER REINFORCEMENT	PILE CAP TO G.BEAM REINFORCEMENT
A-9	2-16" DIA	1423.80	1389.80	34'-0"	2x4 #6 x 18'-0" VERT 2x19 3A01 @12" TIES 2x1 #8 x 18'-0" VERT@MID	4 6A01 DWLS
A-10	2-16" DIA	1423.80	1387.80	36'-0"	2x4 #6 x 18'-0" VERT 2x19 3A01 @12" TIES	4 6A01 DWLS
A-1	4-16" DIA	1423.80	1378.80	45'-0"	2x1 #8 x 18'-0" VERT@MID 4x4 #6 x 18'-0" VERT 4x19 3A01 @12" TIES	1 0/101 0/423
					4x1 #8 x 18'-0" VERT@MID 4x4 #6 x 18'-0" VERT	8 6A01 DWLS
A-3	4-16" DIA	1423.80	1367.80	56'-0"	4x19 3A01 @12" TIES 4x1 #8 x 18'-0" VERT@MID 4x4 #6 x 18'-0" VERT	8 6A01 DWLS
A-7	4-16" DIA	1423.80	1366.80	57'-0"	4x19 ["] 3A01 @12" TIES 4x1 #8 x 18'-0" VERT@MID	8 6AO1 DWLS
A-8	4-16" DIA	1423.80	1366.80	57'-0"	4x4 #6 x 18'-0" VERT 4x19 3A01 @12" TIES 4x1 #8 x 18'-0" VERT@MID	8 6A01 DWLS
A-9	4-16" DIA	1423.80	1365.80	58'-0"	4x4 #6 x 18'-0" VERT 4x19 3A01 @12" TIES 4x1 #8 x 18'-0" VERT@MID	8 6A01 DWLS
A-10	4-16" DIA	1423.80	1371.80	52'-0"	4x4 #6 x 18'-0" VERT 4x19 3A01 @12" TIES	
B-1	4-16" DIA	1423.80	1368.80	55'-0"	4x1 #8 x 18'-0" VERT@MID 4x4 #6 x 18'-0" VERT 4x19 3A01 @12" TIES	8 6A01 DWLS
B-3	4-16" DIA	1427.80	1369.80	58'-0"	4x1 #8 x 18'-0" VERT@MID 4x4 #6 x 18'-0" VERT 4x19 3A01 @12" TIES	8 6A01 DWLS
					4x1 #8 x 18'-0" VERT@MID 2x4 #6 x 18'-0" VERT	4 4A31 @24" DWLS
B-3.1	2-16" DIA	1427.80	1386.80	41'-0"	2x19 3A01 @12" TIES 2x1 #8 x 18'-0" VERT@MID 4x4 #6 x 18'-0" VERT	2 4A31 @24" DWLS
B-7	4-16" DIA	1427.80	1364.80	63'-0"	4x19 3A01 @12" TIES 4x1 #8 x 18'-0" VERT@MID	4 4A31 @24" DWLS
B-8	4-16" DIA	1427.80	1362.80	65'-0"	4x4 #6 x 18'-0" VERT 4x19 3A01 @12" TIES 4x1 #8 x 18'-0" VERT@MID	4 4A31 @24" DWLS
B-9	4-16" DIA	1427.80	1366.80	61'-0"	4x4 #6 x 18'-0" VERT 4x19 3A01 @12" TIES 4x1 #8 x 18'-0" VERT@MID	4 4A31 @24" DWLS
B-10	4-16" DIA	1427.80	1374.80	53'-0"	4x4 #6 x 18'-0" VERT 4x19 3A01 @12" TIES 4x1 #8 x 18'-0" VERT@MID	4 4A31 @24" DWLS
C-1	4-16" DIA	1423.80	1369.80	54'-0"	4x4 #6 x 18'-0" VERT 4x19 3A01 @12" TIES	
C-3	4-16" DIA	1427.80	1372.80	55'-0"	4x1 #8 x 18'-0" VERT@MID 4x1 #8 x 20'-0" VERT@MID	8 6A01 DWLS
C-3.1 C-7	2-16" DIA 4-16" DIA	1427.80 1427.80	1390.80 1367.80	37'-0" 60'-0"	2x1 #8 x 20'-0" VERT@MID 4x1 #8 x 20'-0" VERT@MID	
C-8	4-16" DIA	1427.80	1366.80	61'-0"	4x1 #8 x 20'-0" VERT@MID	
C-9 C-10	4-16" DIA 4-16" DIA	1427.80 1427.80	1369.80 1378.80	58'-0" 49'-0"	4x1 #8 x 20'-0" VERT@MID 4x1 #8 x 20'-0" VERT@MID	
D-1	4-16" DIA	1427.80	1369.80	54'-0"	4x4 #6 x 18'-0" VERT 4x19 3A01 @12" TIES	
D-3	4-16" DIA	1427.80	1372.80	55'-0"	4x1 #8 x 18'-0" VERT@MID 4x1 #8 x 20'-0" VERT@MID	8 6A01 DWLS
D-3.1 D-7	2-16" DIA 4-16" DIA	1427.80 1427.80	1390.80 1367.80	37'-0" 60'-0"	2x1 #8 x 20'-0" VERT@MID 4x1 #8 x 20'-0" VERT@MID	
D-8	4-16" DIA	1427.80	1366.80	61'-0"	4x1 #8 x 20'-0" VERT@MID	
D-9 D-10	4-16" DIA 4-16" DIA	1427.80 1427.80	1369.80 1376.80	58'-0" 51'-0"	4x1 #8 x 20'-0" VERT@MID 4x1 #8 x 20'-0" VERT@MID	
E-1	4-16" DIA	1423.80	1369.80	54'-0"	4x4 #6 x 18'-0" VERT 4x19 3A01 @12" TIES 4x1 #8 x 18'-0" VERT@MID	8 6A01 DWLS
E-3	4-16" DIA	1423.80	1364.80	59'-0"	4x4 #6 x 18'-0" VERT 4x19 3A01 @12" TIES	
E-3.1	4-16" DIA	1423.80	1384.80	39'-0"	4x1 #8 x 18'-0" VERT@MID 4x6 #6 x 23'-0" VERT 4x24 3A01 @12" TIES	
E-7	4-16" DIA	1423.80	1358.80	65'-0"	4x1 #8 x 23'-0" VERT@MID 4x4 #6 x 18'-0" VERT 4x19 3A01 @12" TIES	8 6A01 DWLS
					4x1 #8 x 18'-0" VERT@MID 4x4 #6 x 18'-0" VERT	8 6A01 DWLS
E-8	4-16" DIA	1423.80	1352.80	71'-0"	4x19 [°] 3A01 @12" TIES 4x1 #8 x 18'-0" VERT@MID 4x4 #6 x 18'-0" VERT	8 6A01 DWLS
E-9	4-16" DIA	1423.80	1357.80	66'-0"	4x19 ["] 3A01 @12" TIES 4x1 #8 x 18'-0" VERT@MID	8 6A01 DWLS
E-10	4-16" DIA	1423.80	1365.80	58'-0"	4x4 #6 x 18'-0" VERT 4x19 3A01 @12" TIES 4x1 #8 x 18'-0" VERT@MID	8 6A01 DWLS
F-5	3-16" DIA	1423.80	1382.80	41'-0"	3x6 #6 x 23'-0" VERT 3x24 3A01 @12" TIES 3x1 #8 x 23'-0" VERT@MID	8 6A01 DWLS
F-6	4-16" DIA	1423.80	1364.80	59'-0"	4x6 #6 x 33'-0" VERT 4x34 3A01 @12" TIES 4x1 #8 x 33'-0" VERT@MID	8 6A01 DWLS
F-8	4-16" DIA	1427.80	1354.80	73'-0"	4x1 #8 x 20'-0" VERT@MID	
F-9 F-10	4-16" DIA 4-16" DIA	1427.80 1427.80	1359.80 1368.80	68'-0" 59'-0"	4x1 #8 x 20'-0" VERT@MID 4x1 #8 x 20'-0" VERT@MID	
G-2	3-16" DIA	1427.80	1386.80	37'-0"	3x4 #6 x 18'-0" VERT 3x19 3A01 @12" TIES	
G-4	4-16" DIA	1423.80	1392.80	31'-0"	3x1 #8 x 18'-0" VERT@MID 4x6 #6 x 23'-0" VERT 4x24 3A01 @12" TIES	8 6A01 DWLS
					4x1 #8 x 23'-0" VERT@MID 4x6 #6 x 33'-0" VERT	8 6A01 DWLS
H-6 H-8	4-16" DIA 4-16" DIA	1423.80 1415.80	1373.80 1363.80	50'-0" 52'-0"	4x34 3A01 @12" TIES 4x1 #8 x 33'-0" VERT@MID 4x1 #8 x 20'-0" VERT@MID	8 6A01 DWLS
H-9	4-16" DIA	1423.80	1367.80	56'-0"	4x6 #6 x 33'-0" VERT 4x34 3A01 @12" TIES	8 6A01 DWG
	3-16" DIA	1427.80	1376.80	51'-0"	4x1 #8 x 33'-0" VERT@MID 3x1 #8 x 20'-0" VERT@MID	8 6A01 DWLS
H-10	4-16" DIA	1423.80	1390.80	33'-0"	4x6 #6 x 33'-0" VERT 4x34 3A01 @12" TIES 4x1 #8 x 33'-0" VERT@MID	8 6A01 DWLS
H-10 J-9		1423.80	1371.80	52'-0"	2x4 #6 x 18'-0" VERT 2x19 3A01 @12" TIES 2x1 #8 x 18'-0" VERT@MID	4 6A01 DWLS
	2-16" DIA		1		1 #8 x 20'-0" VERT@MID	
J-9 J-10 PILE-1	1-16" DIA	1427.80 1427.80	1389.80 1379.80	38'-0" 48'-0"	1 #8 x 20'-0" VERT@MID	
J-9 J-10		1427.80 1427.80 1427.80	1389.80 1379.80 1379.80	38'-0" 48'-0" 48'-0"	1 #8 x 20'-0" VERT@MID 1 #8 x 20'-0" VERT@MID	
J-9 J-10 PILE-1 PILE-2	1-16" DIA 1-16" DIA	1427.80	1379.80	48'-0"	"	
J-9 J-10 PILE-1 PILE-2 PILE-3 PILE-4	1-16" DIA 1-16" DIA 1-16" DIA 1-16" DIA	1427.80 1427.80 1427.80	1379.80 1379.80 1379.80	48'-0" 48'-0" 48'-0"	1 #8 x 20'-0" VERT@MID 1 #8 x 20'-0" VERT@MID	

GRID REFERENCE	PILE QTY/DIA.	TOP ELEVATION	BOTTOM ELEVATION	PILE DEPTH	PIER REINFORCEMENT	PILE CAP TO G.BEAM REINFORCEMENT
PILE-8	1-16" DIA	1427.80	1369.80	58'-0"	1 #8 x 20'-0" VERT@MID	
PILE-9	1-16" DIA	1427.80	1360.80	67'-0"	1 #8 x 20'-0" VERT@MID	
PILE-10	1-16" DIA	1427.80	1360.80	67'-0"	1 #8 x 20'-0" VERT@MID	
PILE-11	1-16" DIA	1427.80	1371.80	56'-0"	1 #8 x 20'-0" VERT@MID	
PILE-12	1-16" DIA	1427.80	1393.80	34'-0"	1 #8 x 20'-0" VERT@MID	
PILE-13	1-16" DIA	1427.80	1393.80	34'-0"	1 #8 x 20'-0" VERT@MID	
PILE-14	1-16" DIA	1427.80	1373.80	54'-0"	6 #6 x 23'-0" VERT 24 3A01 @12" TIES 1 #8 x 23'-0" VERT@MID	
PILE-15	1-16" DIA	1427.80	1379.80	48'-0"	1 #8 x 20'-0" VERT@MID	
PILE-16	1-16" DIA	1417.80	1377.80	40'-0"	1 #8 x 20'-0" VERT@MID	
PILE-17	1-16" DIA	1417.80	1377.80	40'-0"	1 #8 x 20'-0" VERT@MID	
PILE-18	1-16" DIA	1427.80	1390.80	37'-0"	1 #8 x 20'-0" VERT@MID	
PILE-19	1-16" DIA	1427.80	1390.80	37'-0"	1 #8 x 20'-0" VERT@MID	

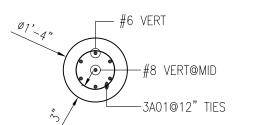

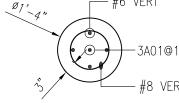

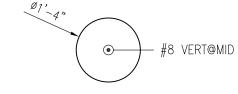


PILE TYPE A&B SCALE = 1/2" = 1'-0"

PILE TYPE C

SCALE = 1/2" = 1'-0"

PILE TYPE
SCALE = 1/2" = 1'-0"

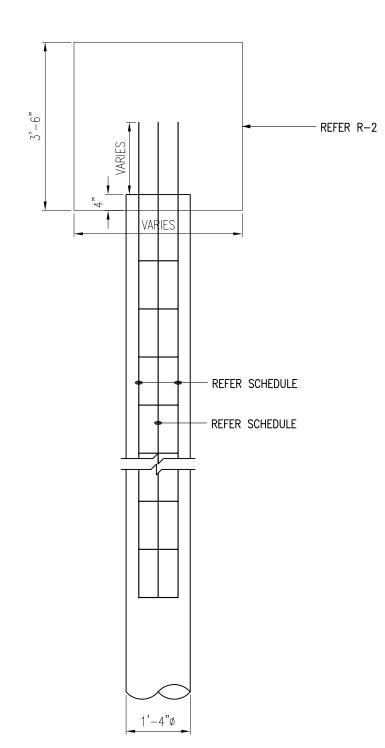

DRILLED PILE

(TYPICAL @192 LOCATIONS)

SCALE = 1/2" = 1'-0"

REF SHEETS: 2-A0.1 thru 2-A6.1 & 2-S1.0 thru 2-S5.3

CD'S ARE DATED ON 09/07/16

FOR PILE CAP REINF. REFER TO DWG.— R2
FOR PIER REINFORCEMENT REFER TO DWG.— R3
FOR BAR BENDING SCHEDULE REFER DWG. — R3A

NOTES:—

1. TYPICAL CLEARANCES

A). For PILE 3" Cover At Sides Typ.

2. A/E/C PLEASE VERIFY THE ALL CLOUDED ITEMS

3. BARS TO BE PLACED AT EQUAL SPACING U.O.N.

4. TILT HOOK TO ACCOMMODATE THE COVER, IF NEED

AND ARE DRAWINGS
ON ARE THE OSED
AWING
AWING
TITLE BLOCK
ECT.

REVISIONS
DATE

ACCORDANCE WITH ACI DETAILING MANUAL, CRSI MANUAL OF STANDARD PRACTICE, AND THE CONTRACT DOCUMENTS. THE CONTRACT DRAWINGS AND SPECIFICATIONS ARE THE PRIMARY DOCUMENTS, AND ARE TO BE USED TOGETHER WITH THE REBAR SHOP DRAWINGS FOR THE ACTUAL PLACEMENT OF THE REINFORCING STEEL THIS DRAWING AND ALL SPECIFICATIONS HERE—ON ARE THE PROPERTY OF SCF CO. AND MAY NOT BE DISCLOSED WITHOUT ITS PRIOR WRITTEN CONSENT. THIS DRAWING PERTAINS TO THE PROJECT MENTIONED IN THE TITLE BLOCKED WITHOUT HERE ACTUALS AND ASSENTED THE STANDARD OF THE PROJECT OF THE PR

NAVA DE CANA			EL GRADE	OT TO BE SCALED
	CONTRACTOR	ENGINEER	REINFORCING STEEL GRADE Grade 60 (420)	THIS DRAWING IS NOT TO BE SCALED

PROJECT NO.


PROJECT NO.


THE ALL CLOUDED ITEMS


AT EQUAL SPACING U.O.N.


MODATE THE COVER, IF NEED


DRAWING NO.

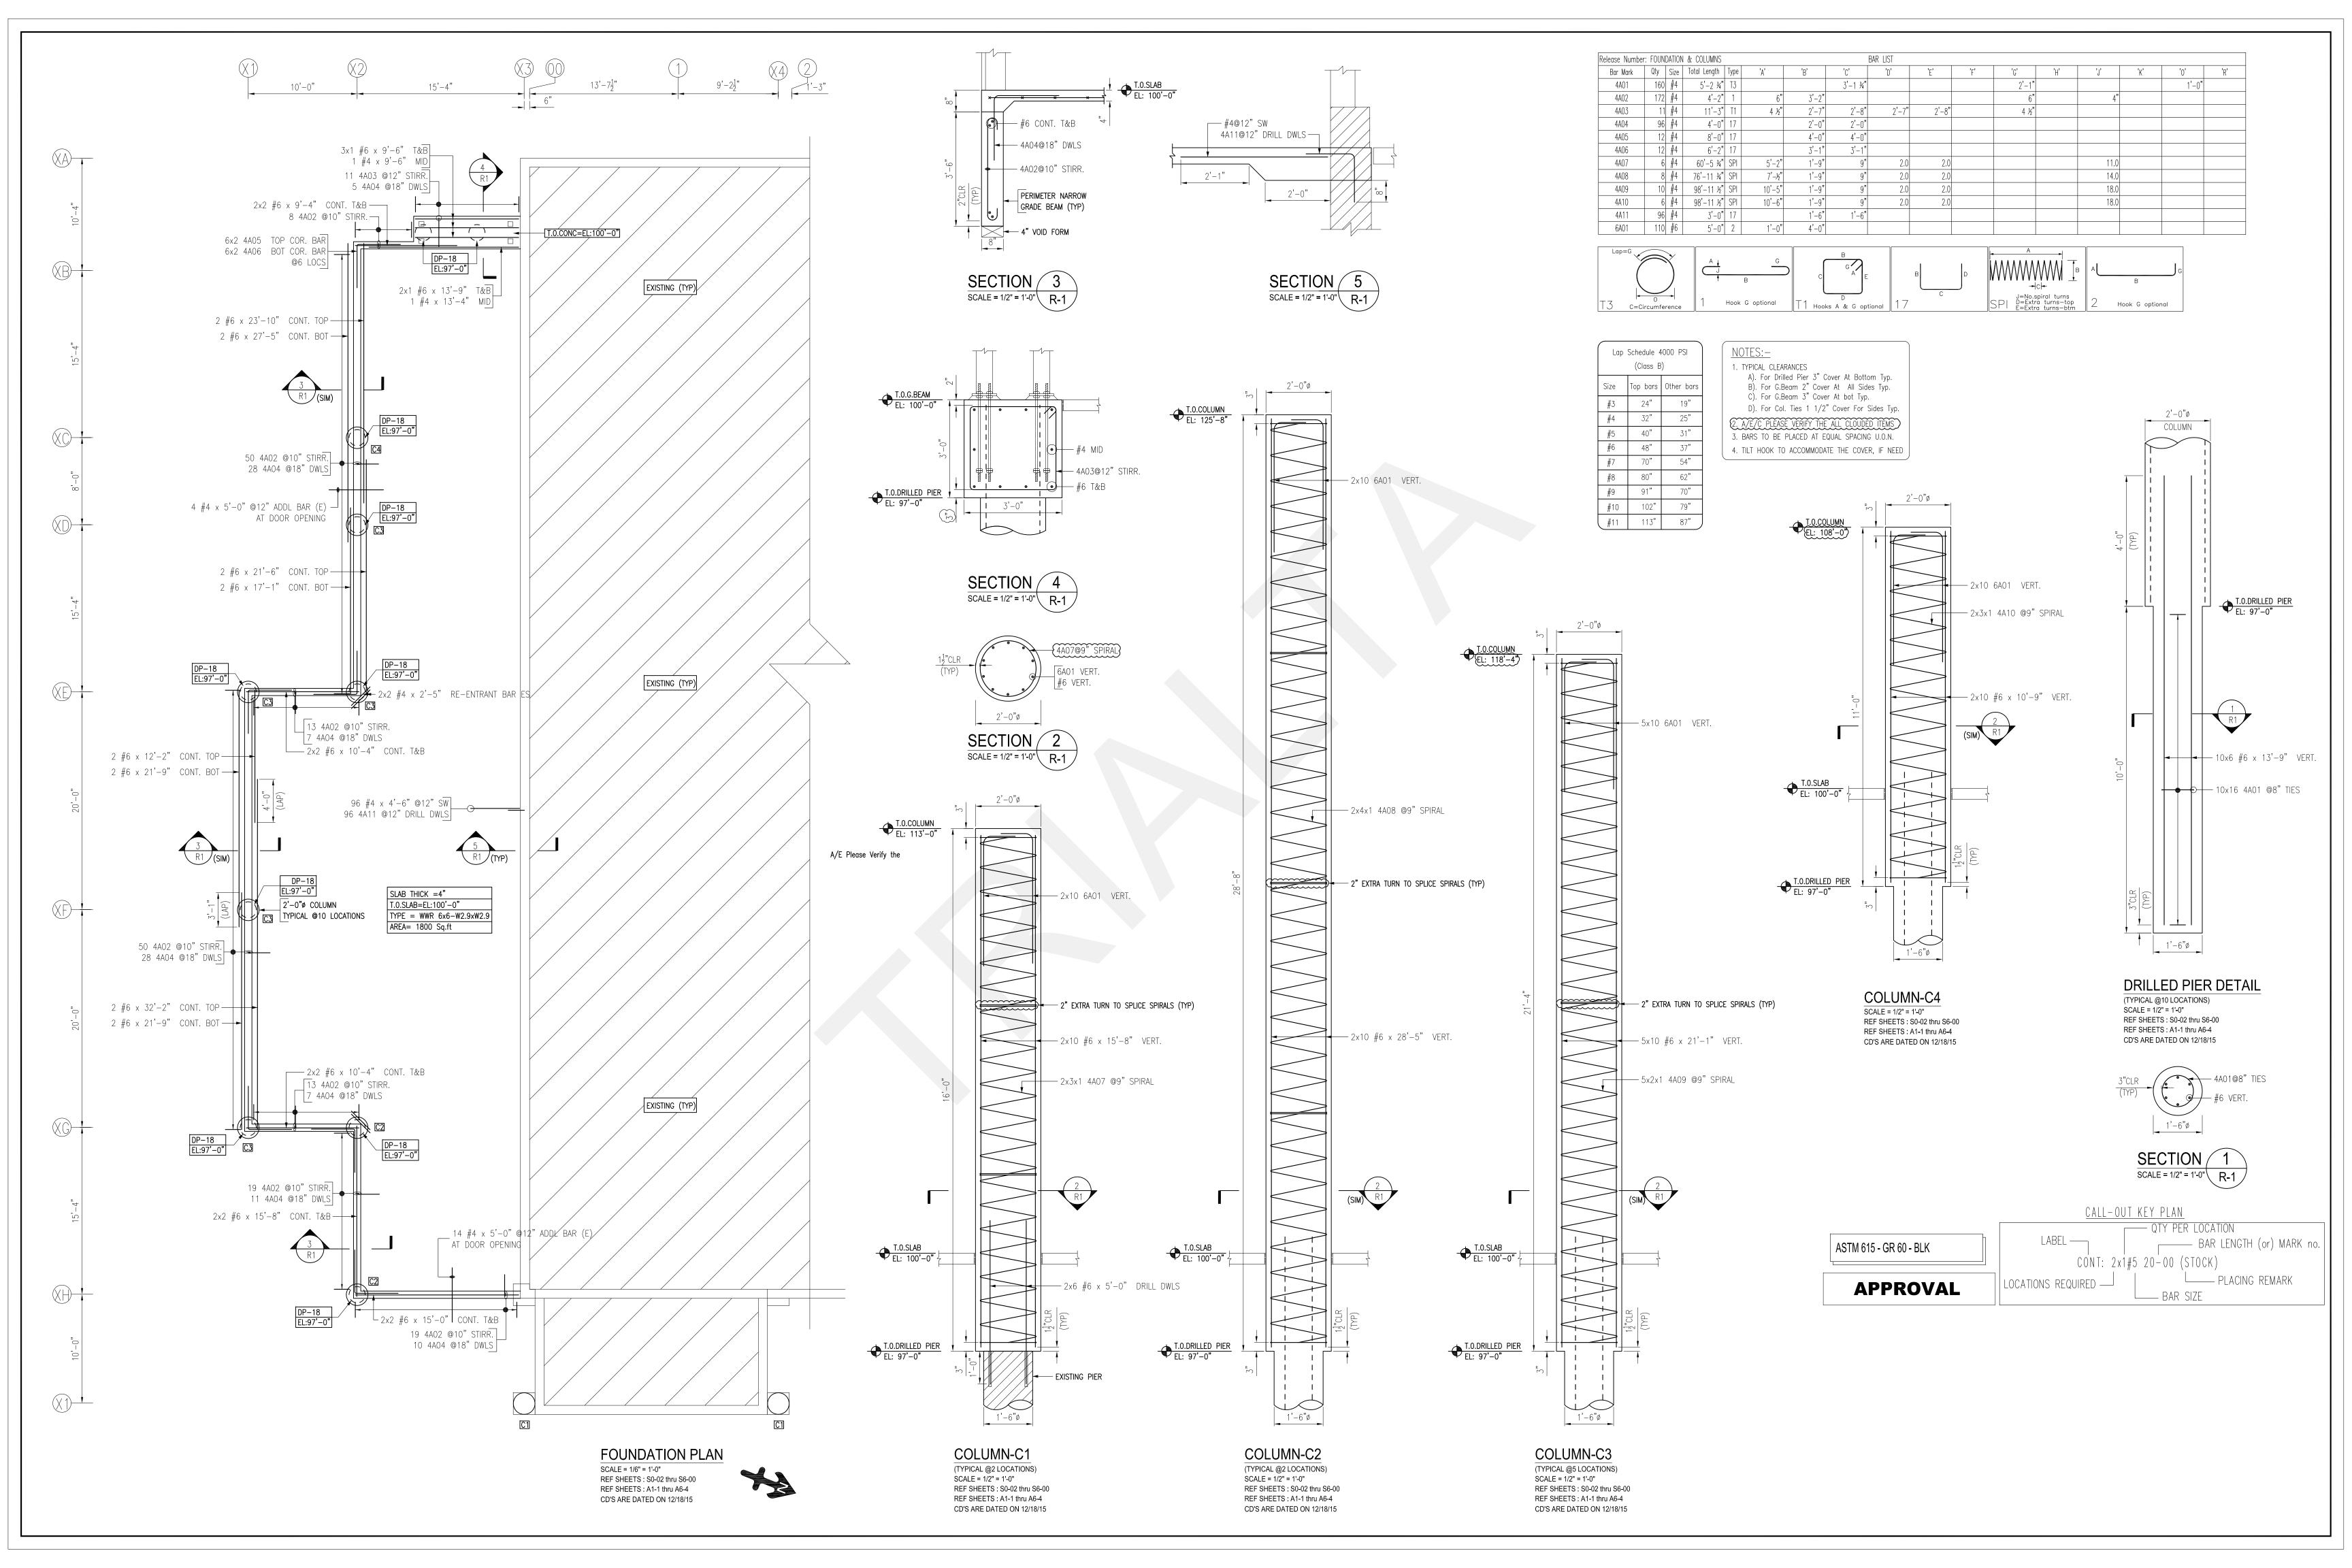


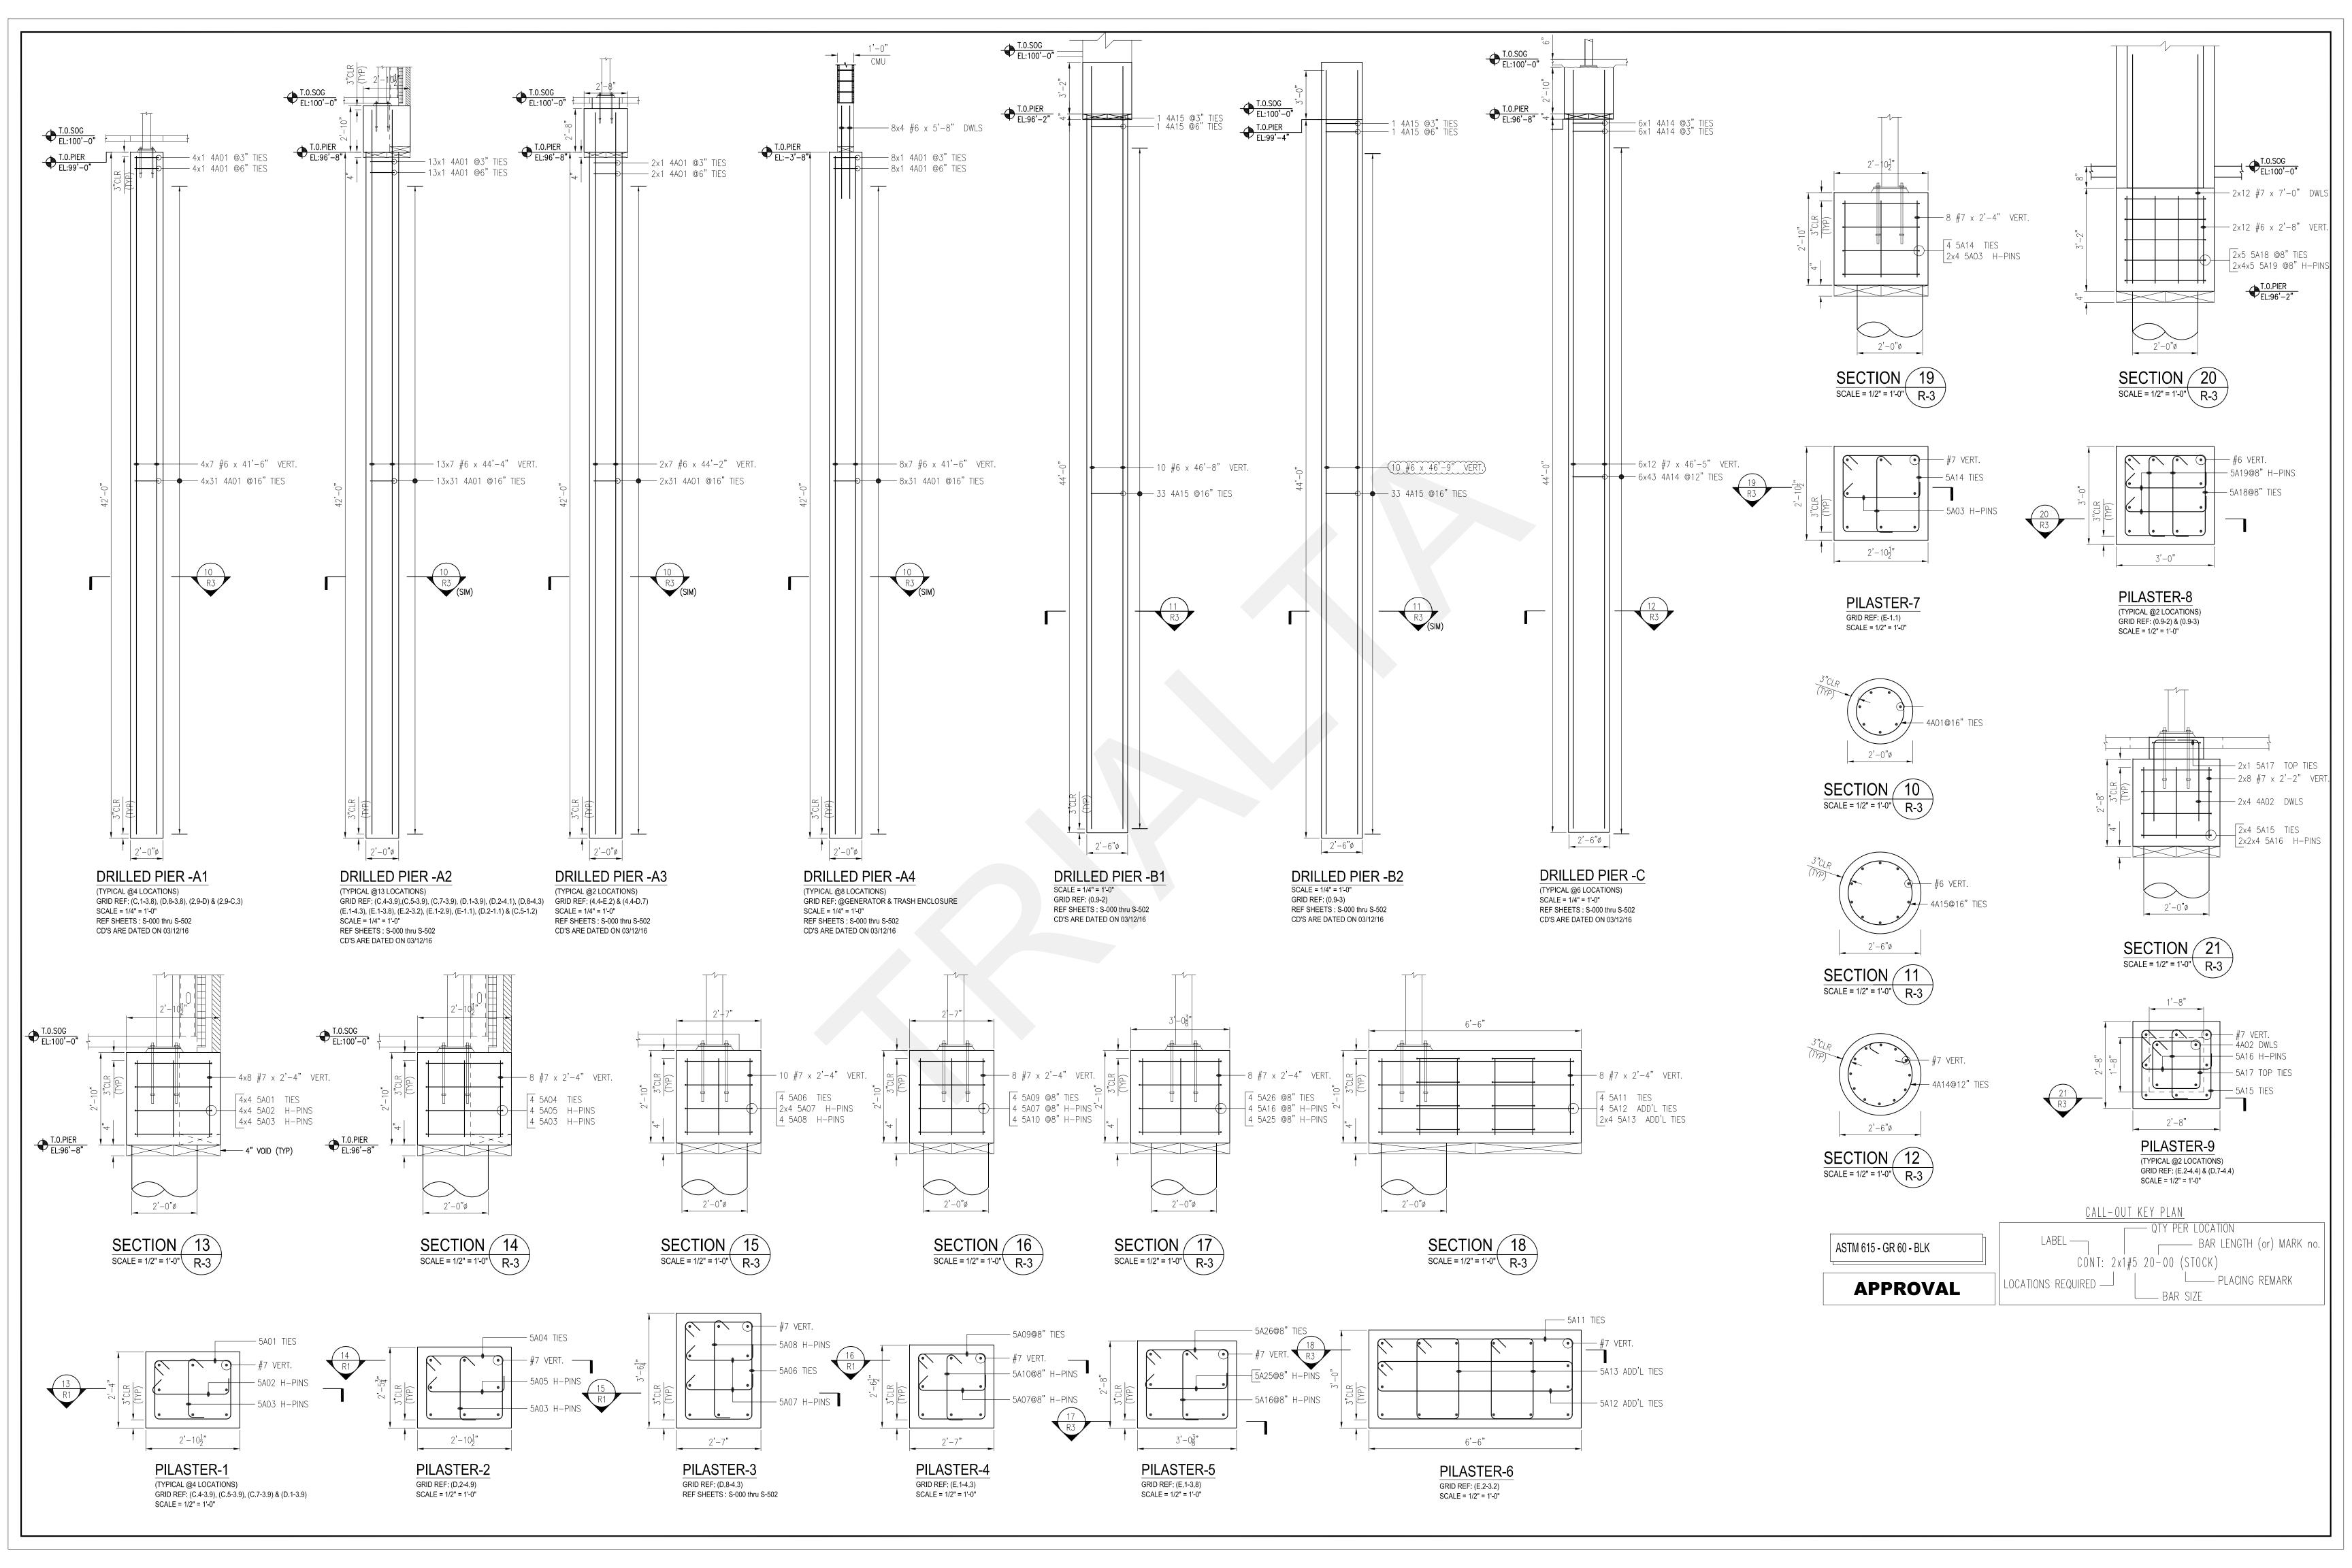


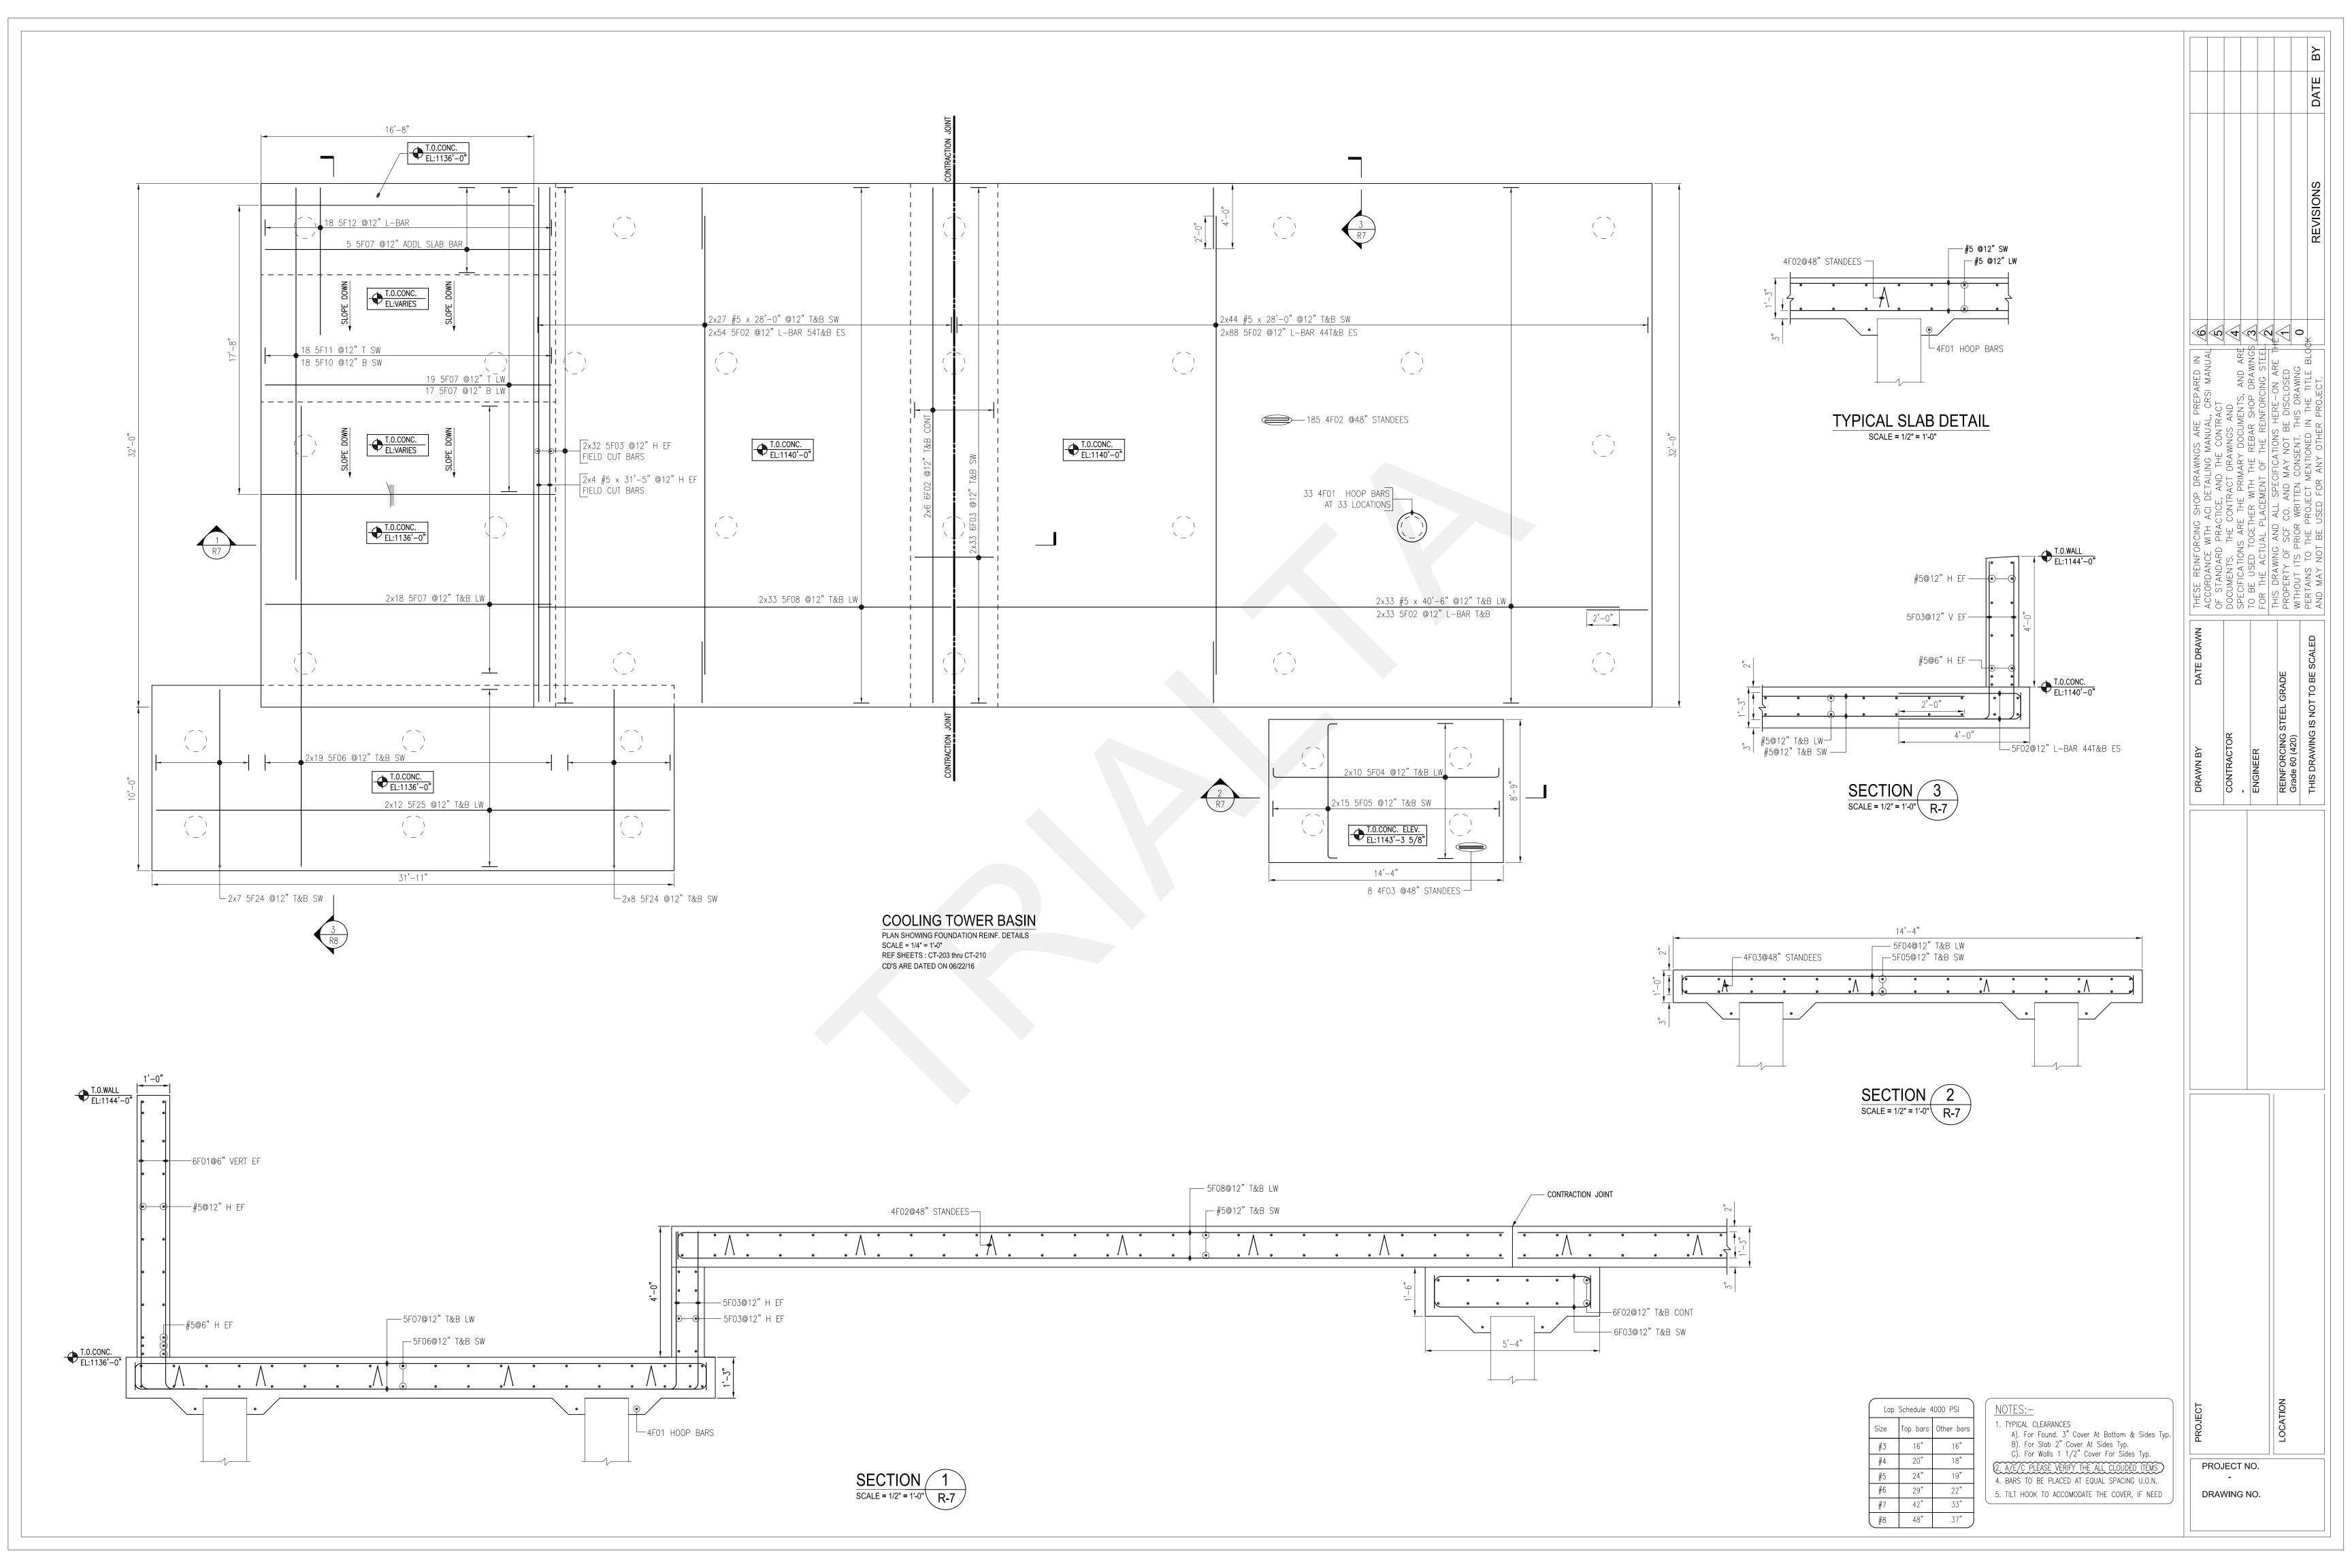


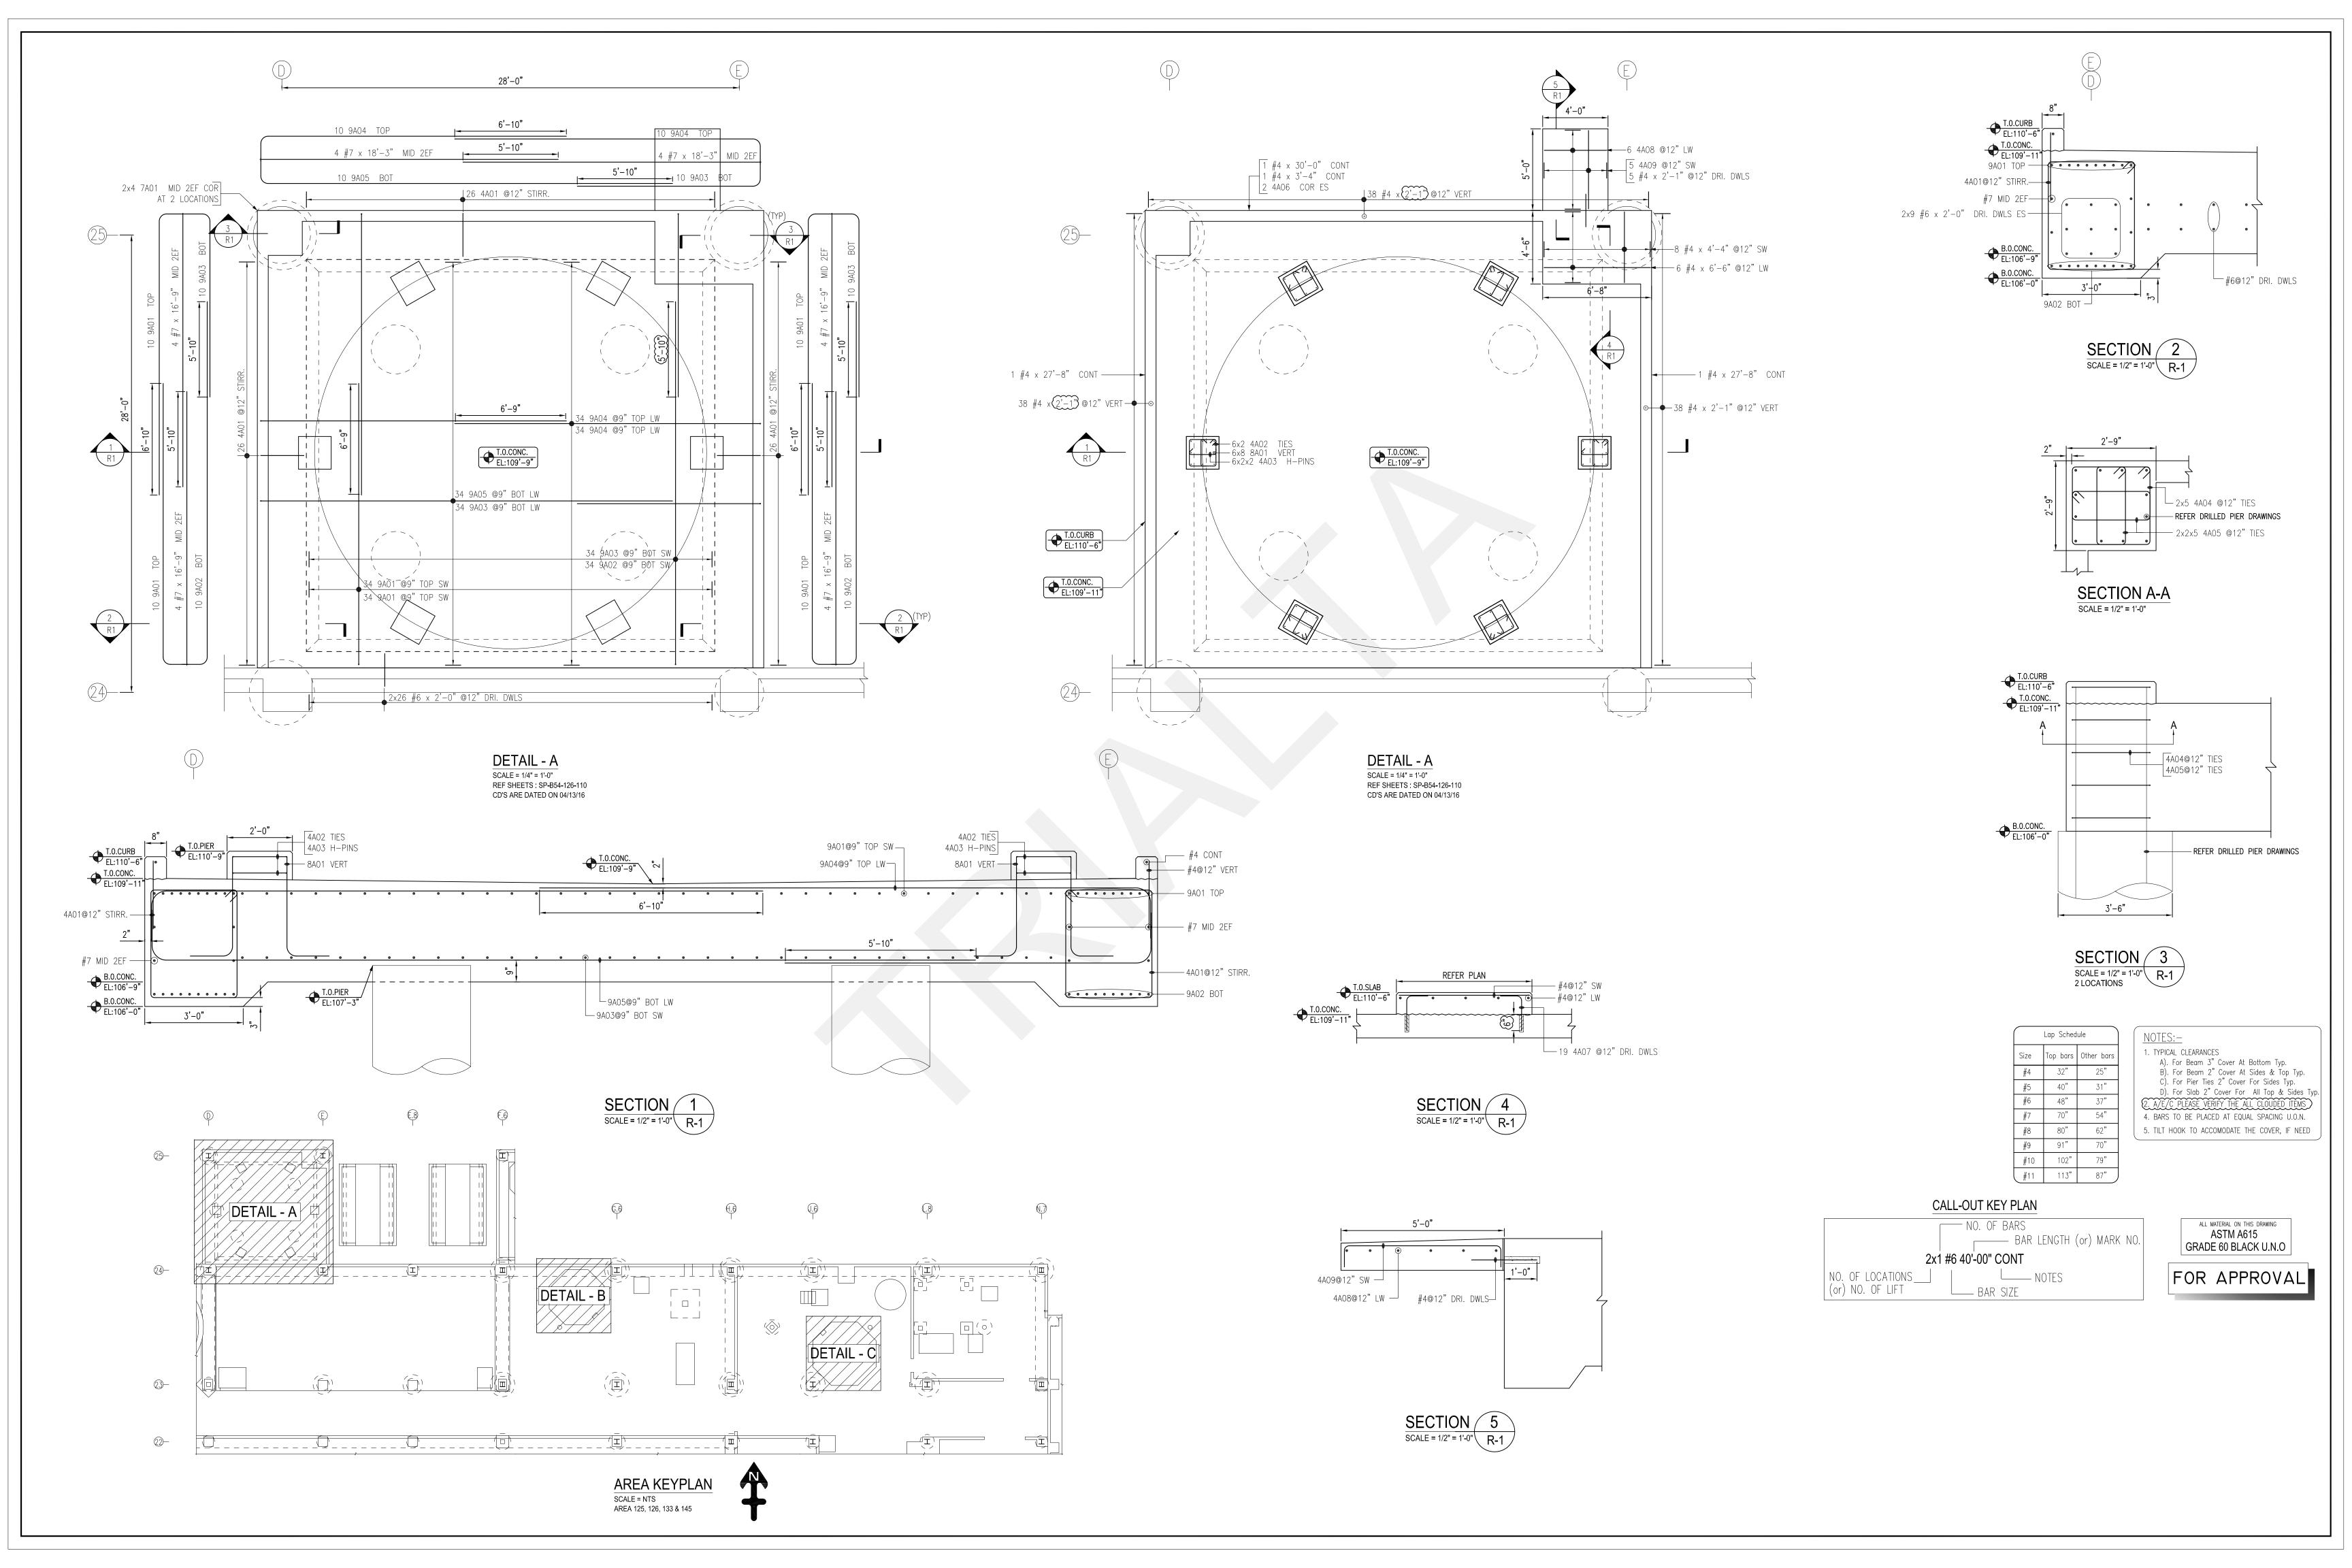


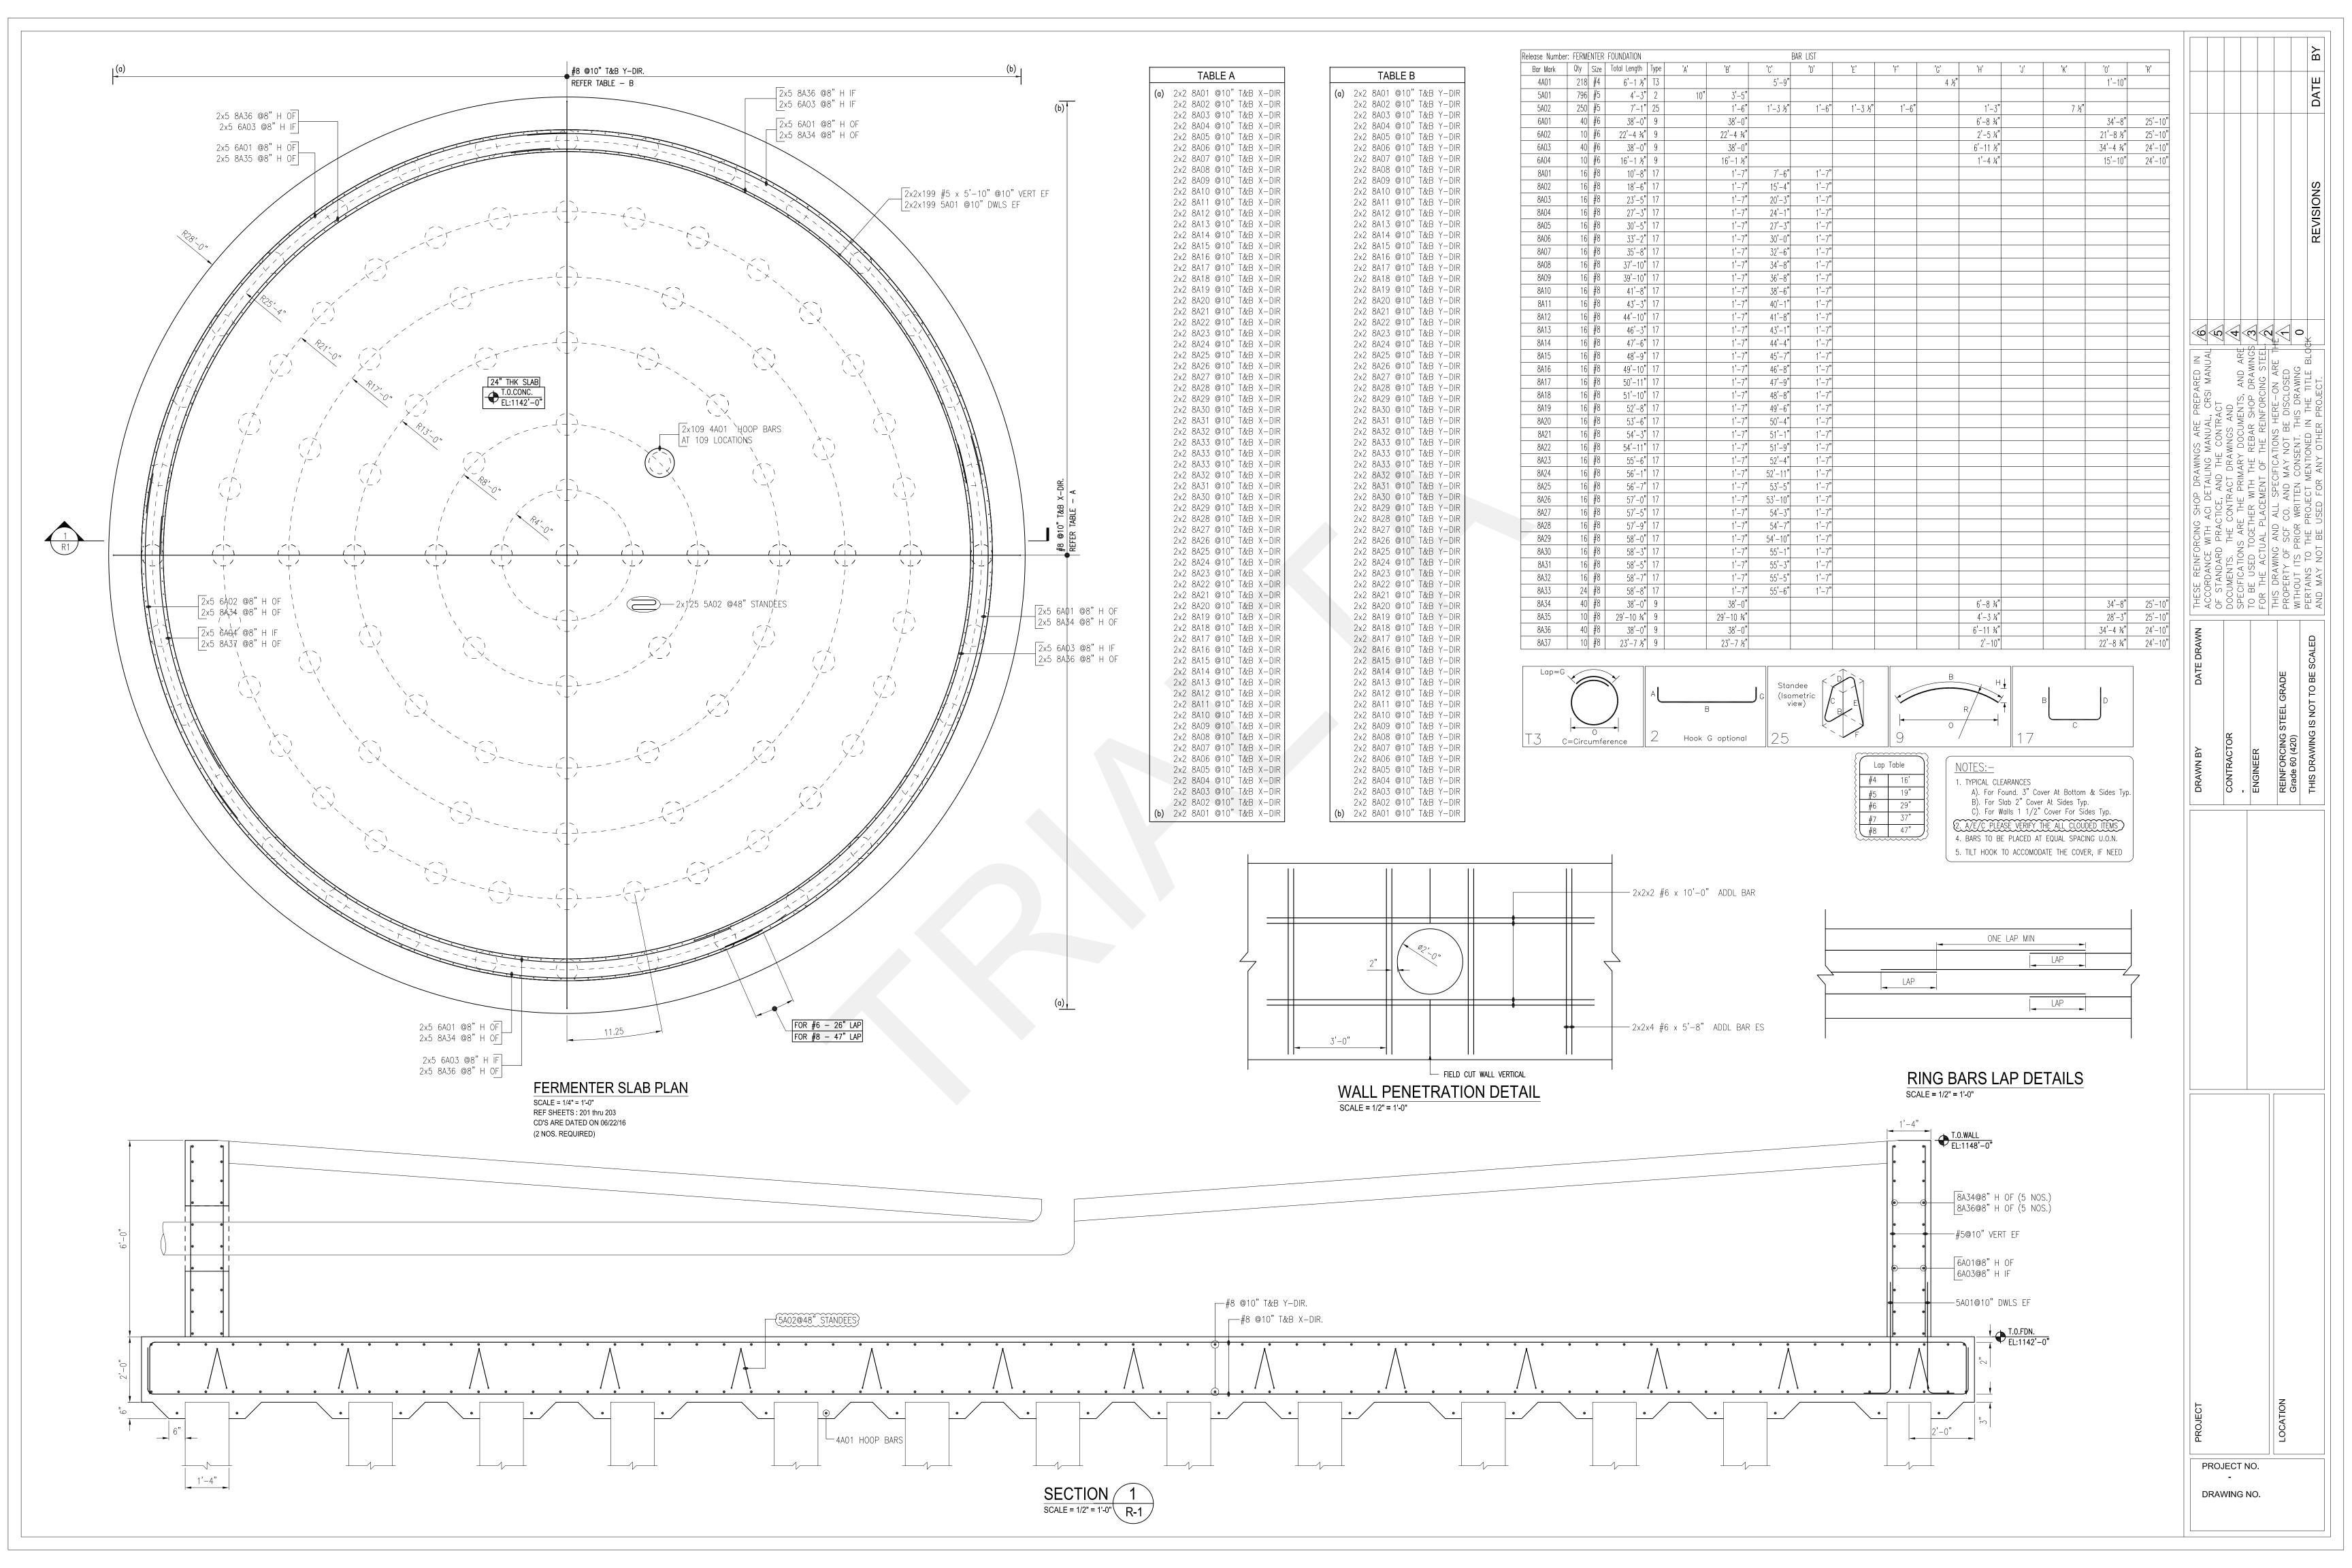


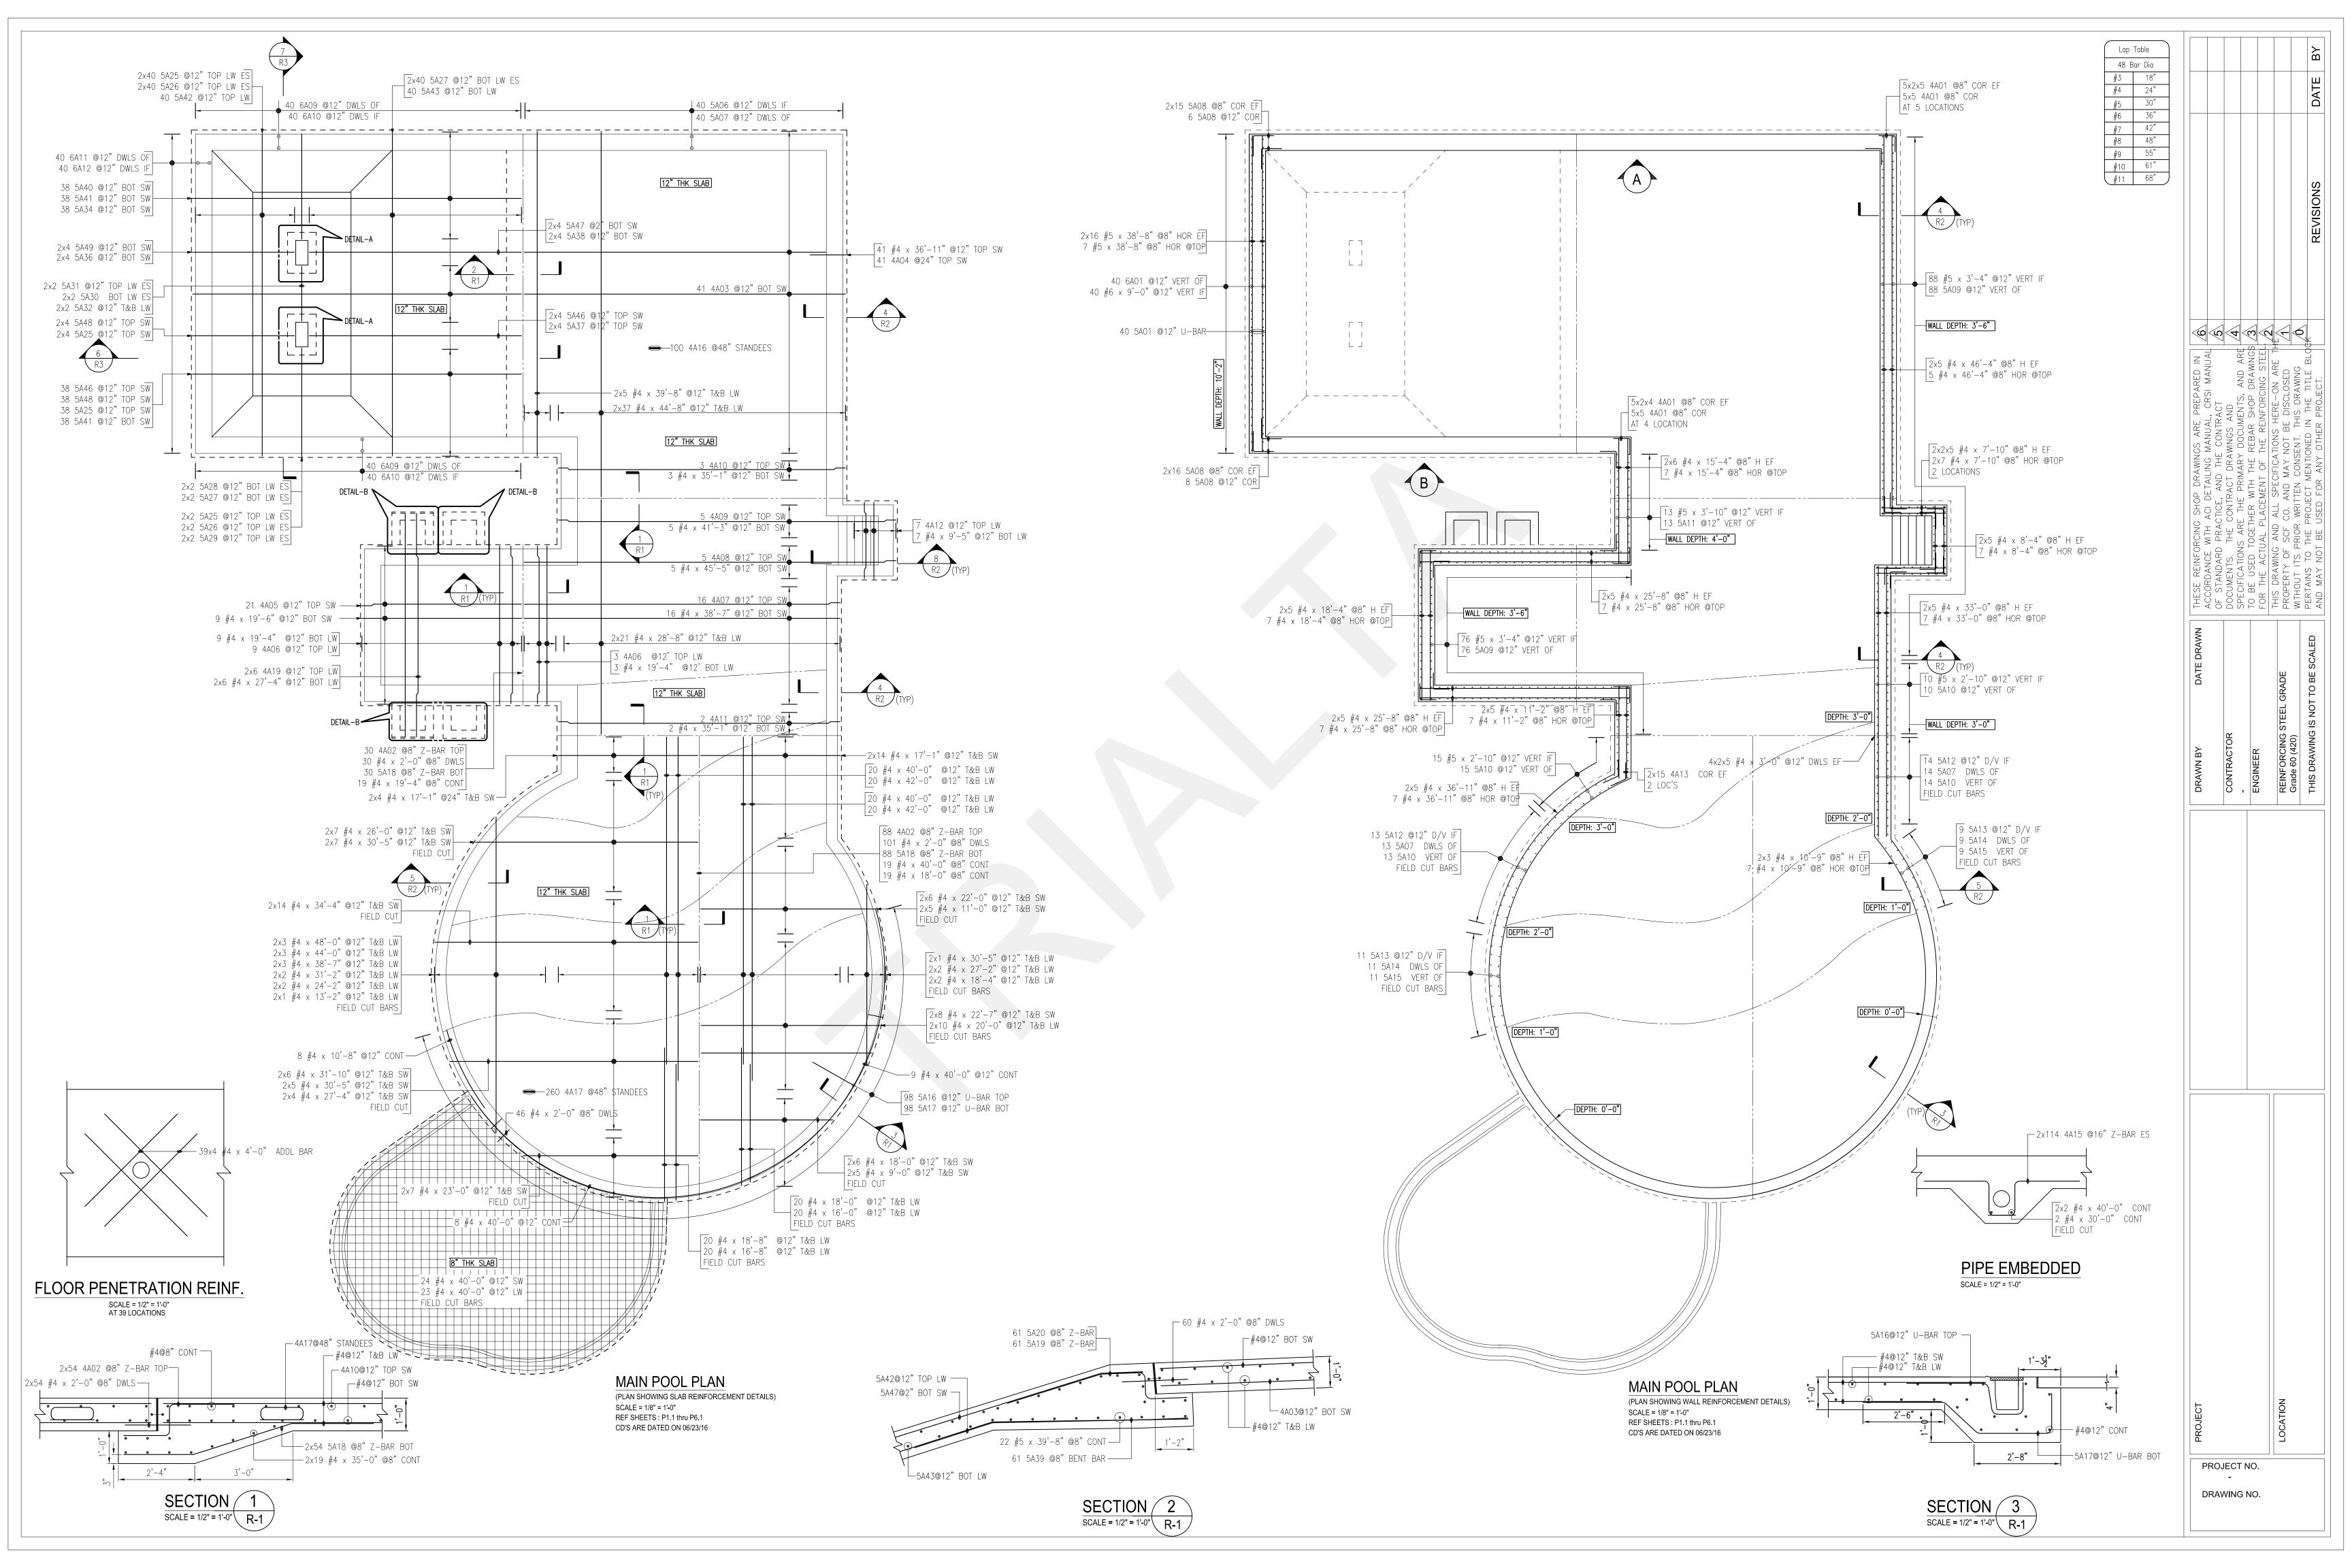


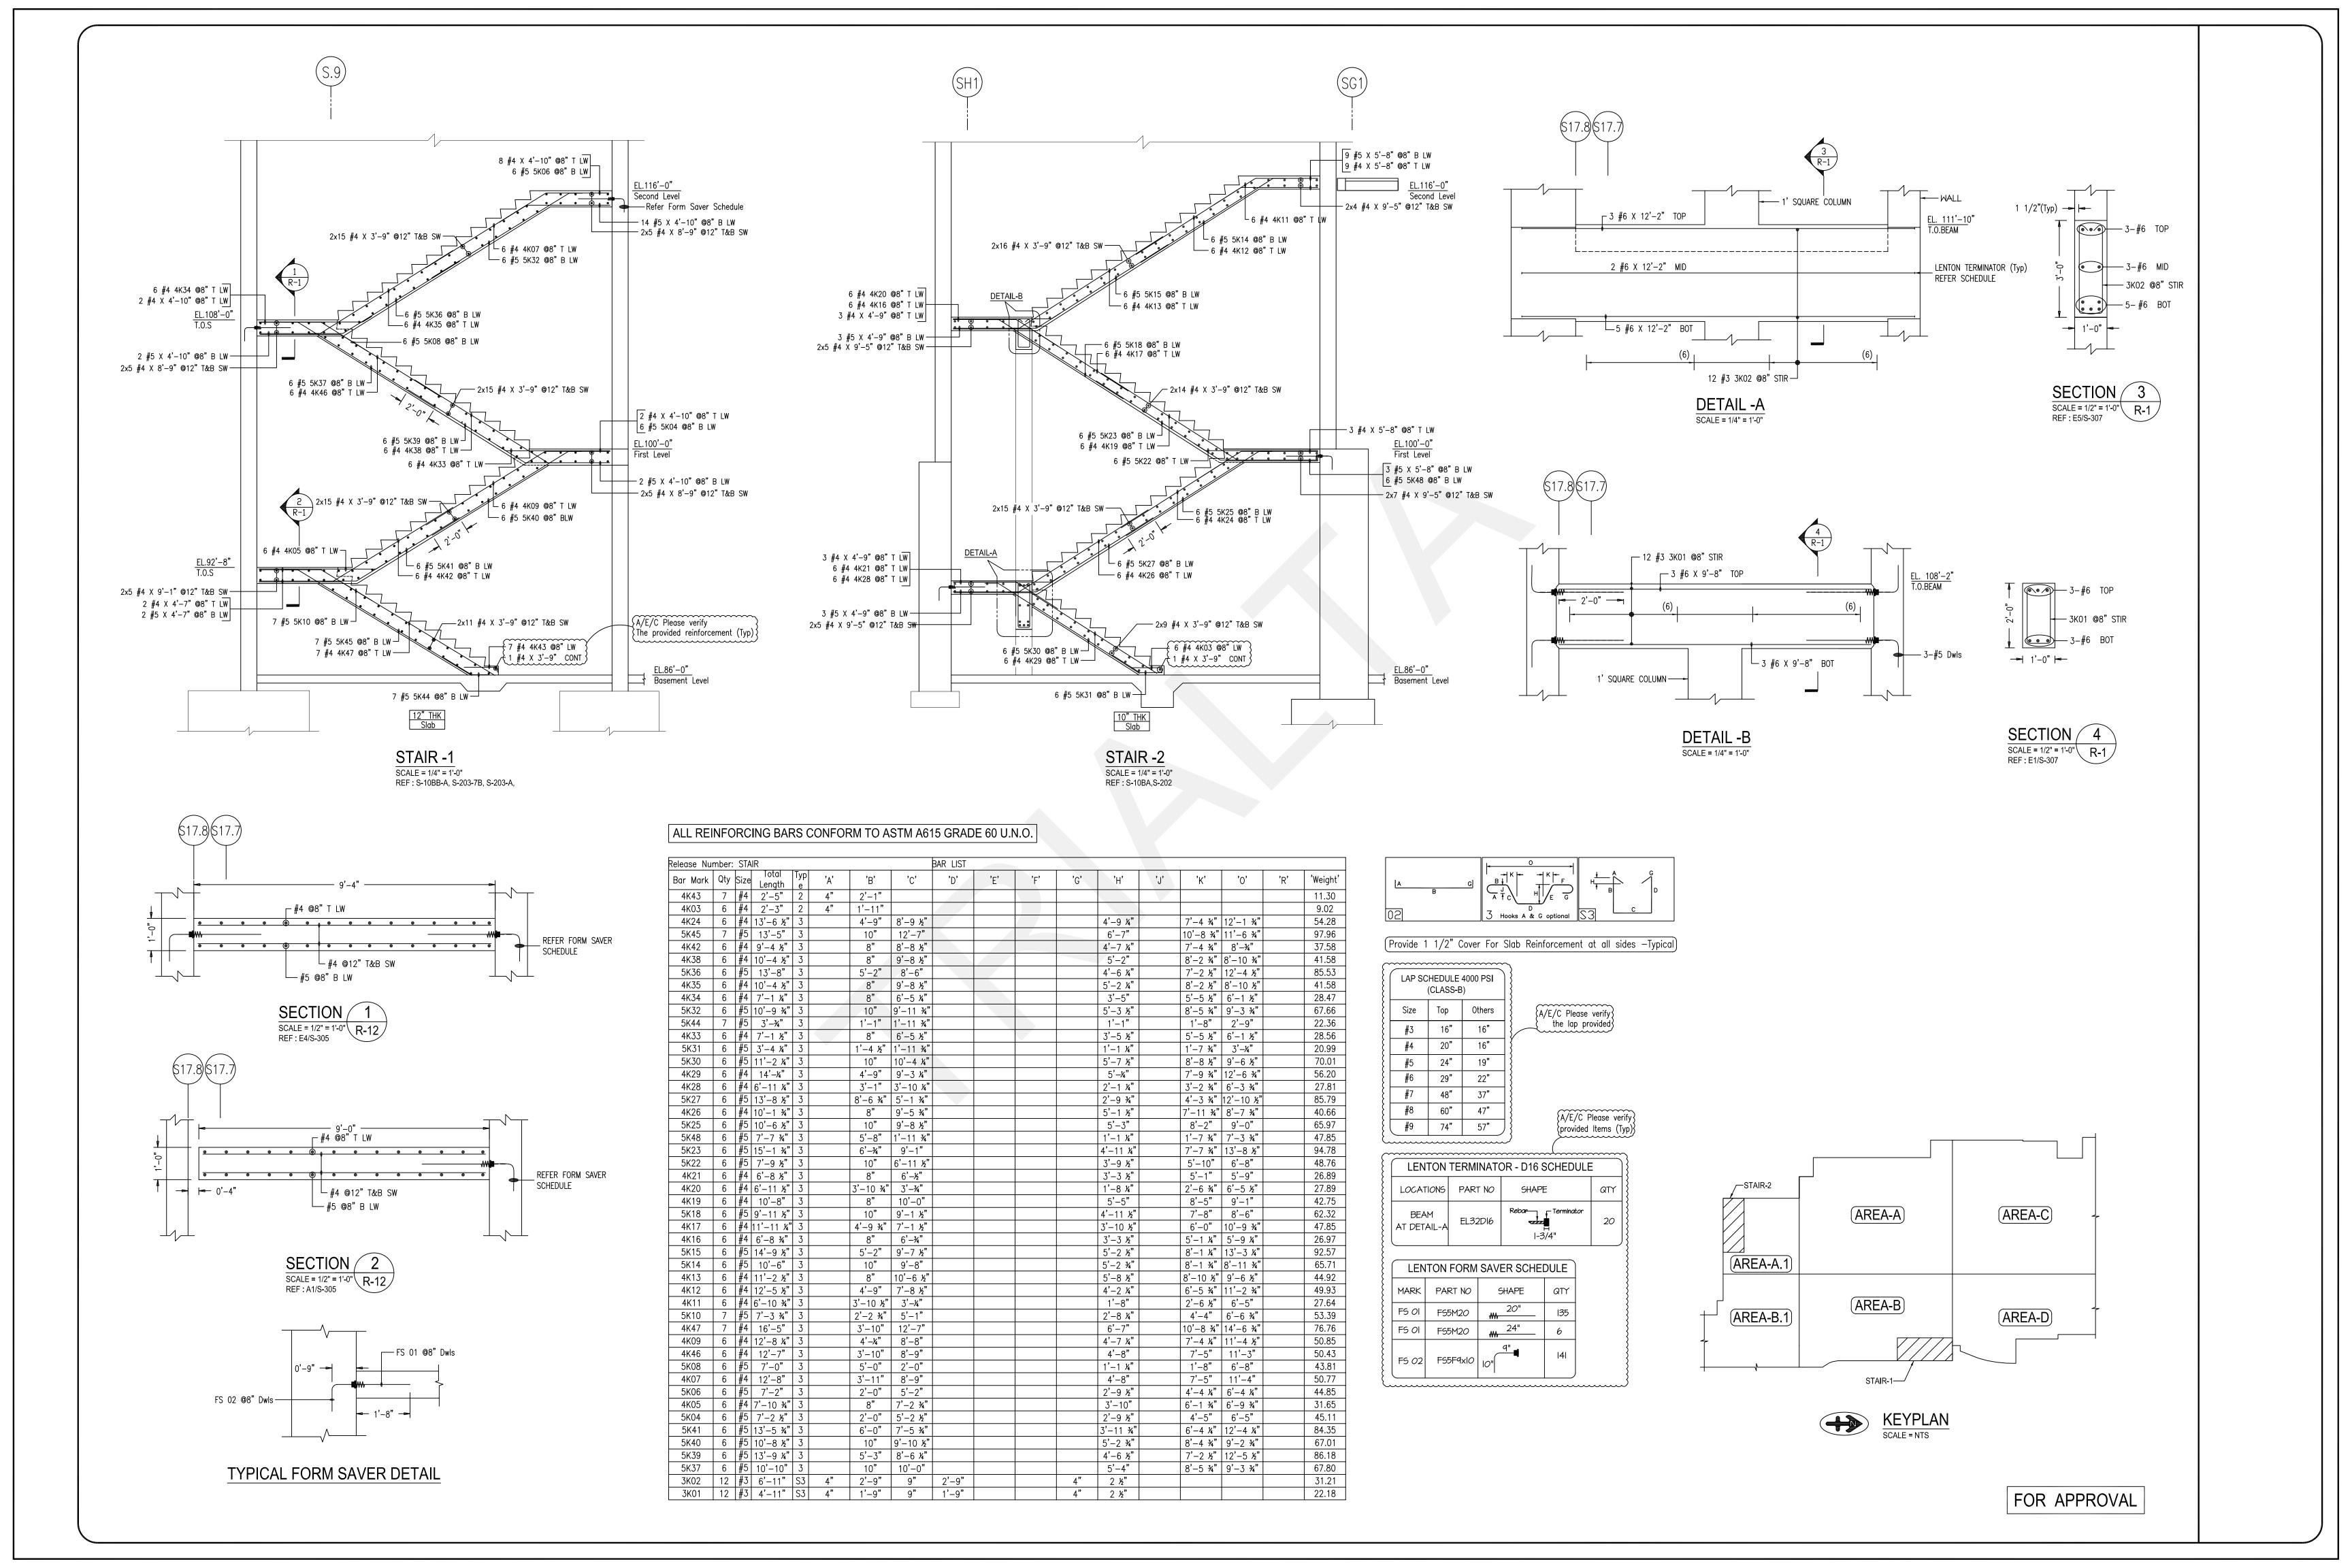


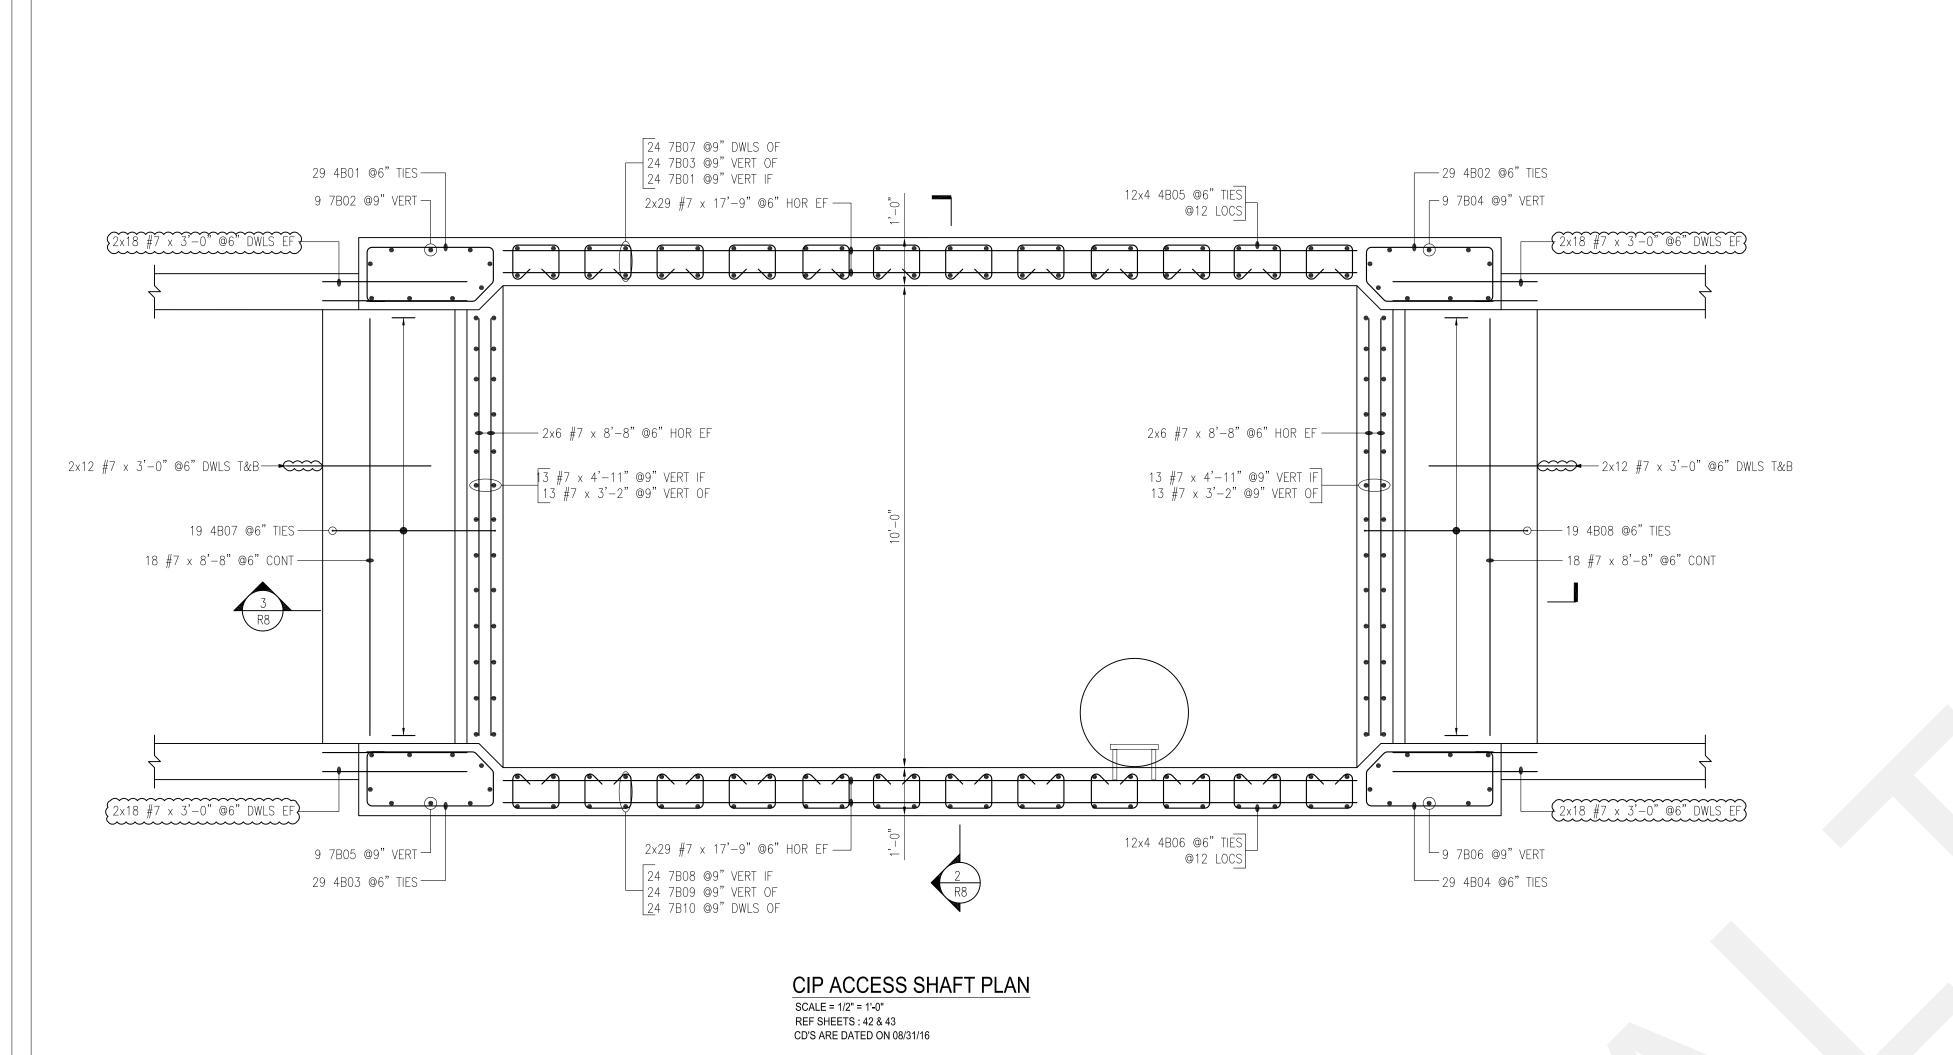

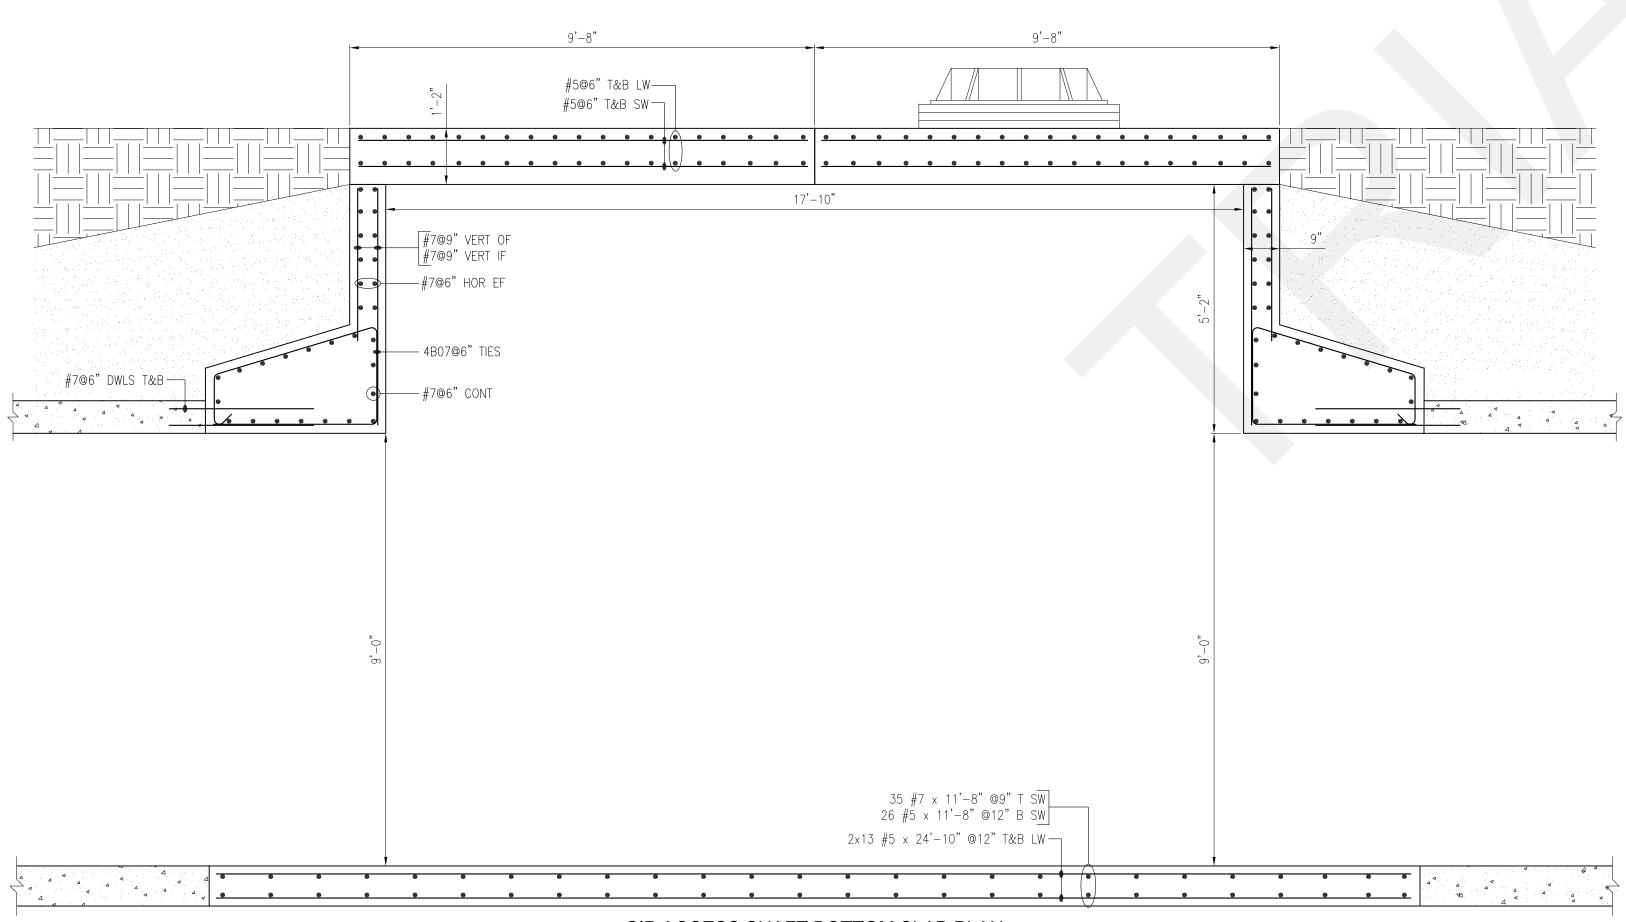

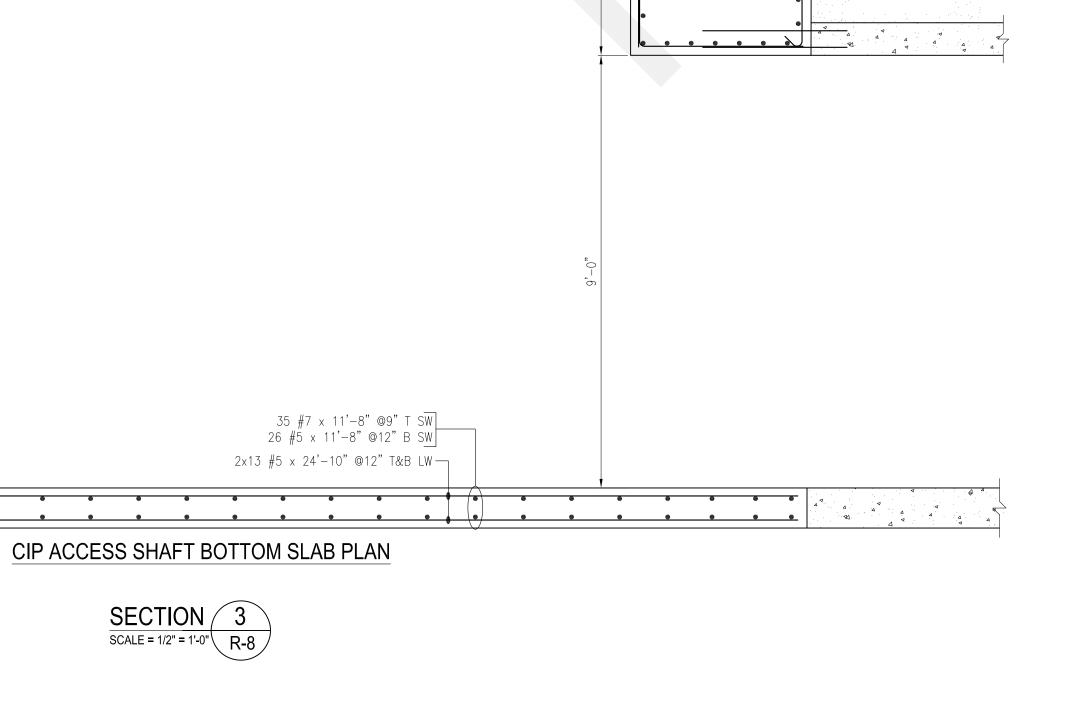

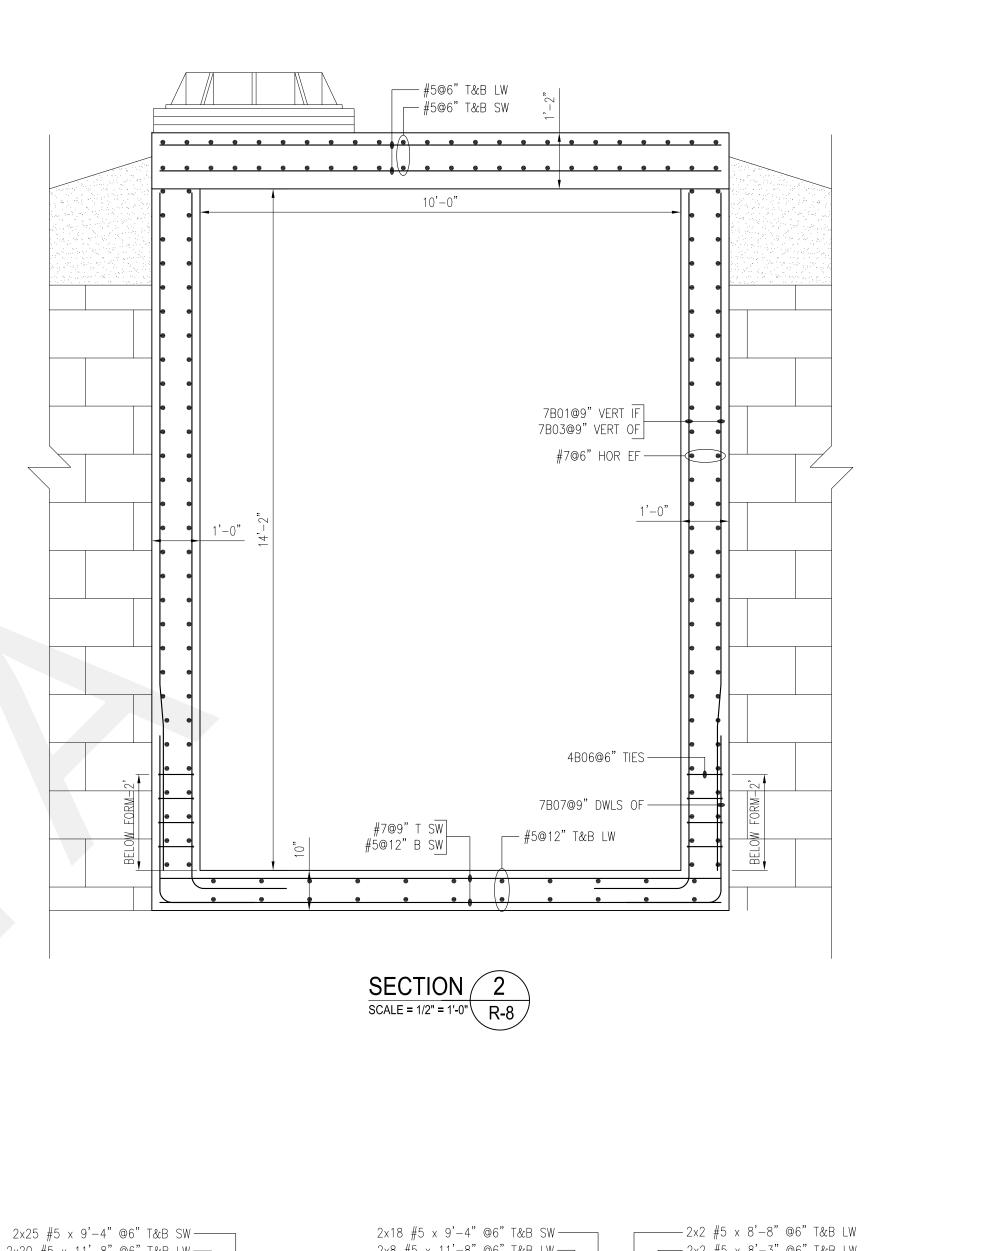

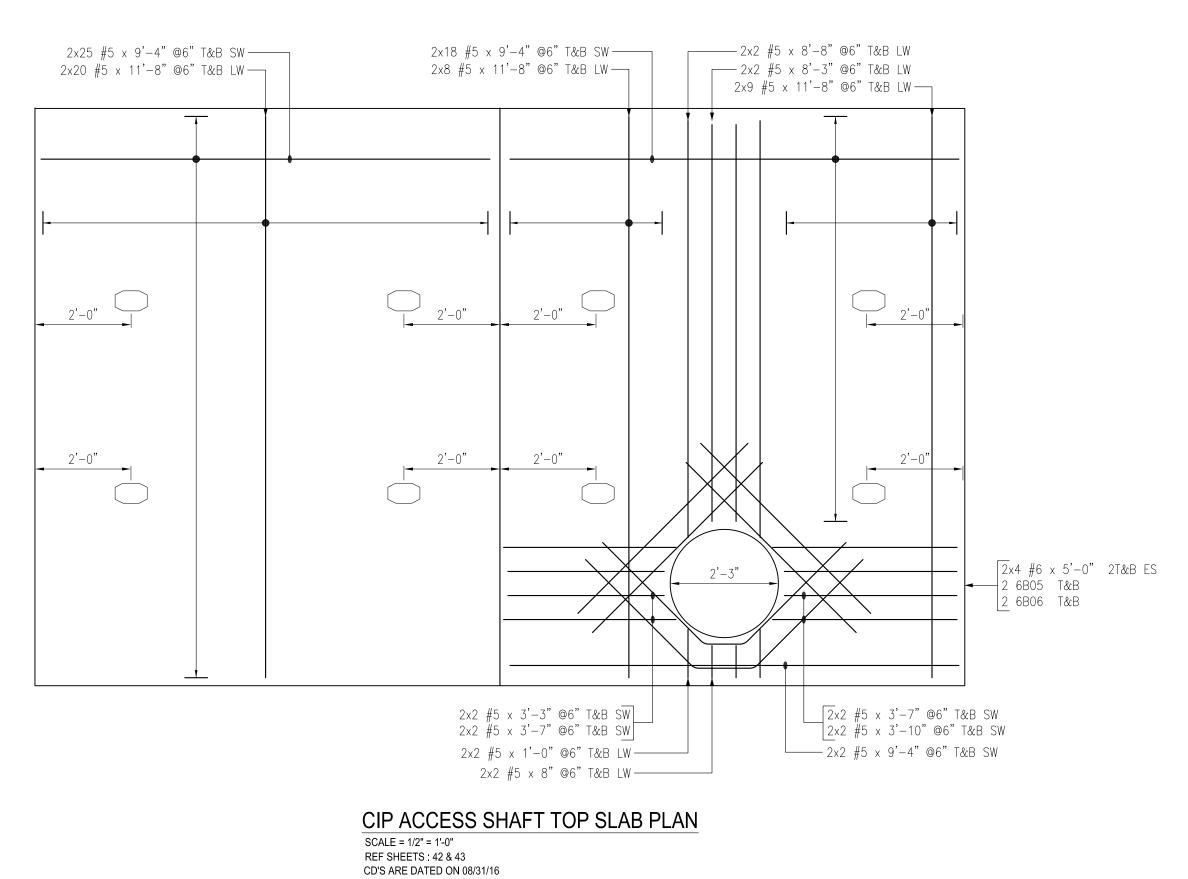

PROJECT NO.

DRAWING NO.